

COMMONWEALTH OF KENTUCKY
BEFORE THE PUBLIC SERVICE COMMISSION

RECEIVED

JAN 25 2008

**PUBLIC SERVICE
COMMISSION**

In the Matter of:

**APPLICATION OF KENTUCKY RSA #4 CELLULAR
GENERAL PARTNERSHIP FOR ISSUANCE OF A CASE NO. 2007-00500
CERTIFICATE OF PUBLIC CONVENIENCE AND
NECESSITY TO CONSTRUCT A CELL SITE
(GREEN NORTH) IN RURAL SERVICE AREA #4
(GREEN) OF THE COMMONWEALTH
OF KENTUCKY**

**APPLICATION FOR A CERTIFICATE
OF PUBLIC CONVENIENCE AND NECESSITY (GREEN NORTH)**

Kentucky RSA #4 Cellular General Partnership (“Kentucky RSA #4”), through counsel, pursuant to KRS 278.020 and 278.040, hereby submits this application for a certificate of public convenience and necessity to construct a cell site to be known as the Green North cell site in and for rural service area (“RSA”) #4 of the Commonwealth of Kentucky, namely the counties of Anderson, Green, Hardin, Larue, Marion, Mercer, Nelson, Spencer, Taylor and Washington, Kentucky.

1. As required by 807 KAR 5:001 Sections 8(1) and (3), and 807 KAR 5:063, Kentucky RSA #4 states that it is a Kentucky general partnership whose full name and post office address are:
Kentucky RSA #4 Cellular General Partnership, 2902 Ring Road, Elizabethtown, Kentucky, 42701.
2. Pursuant to 807 KAR § 1 (1)(b), a copy of the applicant’s applications to the Federal Aviation Administration and Kentucky Airport Zoning Commission are Exhibit “A”. Written authorizations from these agencies will be supplied to the Commission upon their approval.
3. Pursuant to 807 KAR 5:063 §1(1)(d), applicant is submitting as Exhibit “B” a geotechnical investigation report, signed and sealed by a professional engineer registered in Kentucky, that includes boring logs, foundation design recommendations, and a finding as to the susceptibility of the area surrounding the proposed site to flood hazard.

4. Pursuant to 807 KAR 5:063 §1(1)(e), clear directions from the county seat to the proposed site, including highway numbers and street names, if applicable, with the telephone number of the person who prepared the directions are Exhibit “C”.

5. Pursuant to 807 KAR 5:063 §1(1)(f), a copy of the lease for the property on which the tower is proposed to be located, is Exhibit “D”.

6. Pursuant to 807 KAR §1(1)(g), experienced personnel will manage and operate the Green North cell site. The President of Bluegrass Cellular Inc., Mr. Ron Smith, is ultimately responsible for all construction and operations of the cellular system of Kentucky RSA #4, of which system the Green North cell site will be a part. Bluegrass Cellular Inc. provides management services to Kentucky RSA #4 under a management contract, just as it does with three (3) other wireless carriers in the Commonwealth. And, Bluegrass Cellular Inc. has been providing these management services to these other wireless carriers for well over a decade. This extensive management experience with Bluegrass Cellular demonstrates that Bluegrass Cellular Inc.'s management and technical ability to supervise the operations of a wireless carrier.

7. Pursuant to 807 KAR 5:063 §1(1)(g), Eastpointe Engineering Group, LLC is responsible for the design specifications of the proposed tower (identified in Exhibit “B”).

8. Pursuant to 807 KAR 5:063 §1(1)(h), a site development plan or survey, signed and sealed by a professional engineer registered in Kentucky, that shows the proposed location of the tower and all easements and existing structures within 500 feet of the proposed site on the property on which the tower will be located, and all easements and existing structures within 200 feet of the access drive, including the intersection with the public street system, is Exhibit “B”.

9. Pursuant to 807 KAR 5:063 §1(1)(i), a vertical profile sketch of the tower, signed and sealed by a professional engineer registered in Kentucky, indicating the height of the tower and the placement of all antennas is Exhibit “B”.

10. Pursuant to 807 KAR 5:063 §1(1)(j), the tower and foundation design plans and a description of the standard according to which the tower was designed, signed and sealed by a professional engineer registered in Kentucky, is Exhibit “B”.

11. Pursuant to 807 KAR 5:063 § 1 (1)(k), a map, drawn to a scale no less than one (1) inch equals 200 feet, that identifies every structure and every owner of real estate within 500 feet of the proposed tower, is Exhibit “E”.

12. Pursuant to 807 KAR 5:063 § 1 (1)(l), applicant’s legal counsel hereby affirms that every person who owns property within 500 feet of the proposed tower has been: (i) notified by certified mail, return receipt requested, of the proposed construction; (ii) given the commission docket number under which the application will be processed; and (iii) informed of his right to request intervention.

13. Pursuant to KRS 278.665(2), applicant’s legal counsel hereby affirms that every person who, according to the records of the property valuation administrator, owns property contiguous to the property where the proposed cellular antenna tower will be located has been: (i) notified by certified mail, return receipt requested, of the proposed construction; (ii) given the commission docket number under which the application will be processed; and (iii) informed of his right to request intervention.

14. Pursuant to 807 KAR 5:063 §1(1)(m), a list of the property owners who received the notice together with copies of the certified letters sent to listed property owners, is Exhibit “F”.

15. Pursuant to 807 KAR 5:063 § 1 (1)(n), applicant’s legal counsel hereby affirms that the Green County Judge Executive has been: (i) notified by certified mail, return receipt requested, of the proposed construction; (ii) given the commission docket number under which the application will be processed; and (iii) informed of its right to request intervention.

16. Pursuant to 807 KAR 5:063 §1(1)(o), a copy of the notice sent to the Green County Judge Executive is Exhibit “G”.

17. Pursuant to 807 KAR 5:063 § 1 (1)(p), applicant’s legal counsel hereby affirms that (i) two written notices meeting subsection two (2) of this section have been posted, one in a visible location

on the proposed site and one on the nearest public road; and (ii) the notices shall remain posted for at least two weeks after the application has been filed.

18. Pursuant to 807 KAR 5:063 § 1 (2)(a), applicant's legal counsel affirms that:

(a) A written notice, of durable material at least two (2) feet by four (4) feet in size, stating that "**Kentucky RSA #4 Cellular General Partnership proposes to construct a telecommunications tower on this site,**" including the addresses and telephone numbers of the applicant and the Kentucky Public Service Commission, has been posted and shall remain in a visible location on the proposed site until final disposition of the application; and

(b) A written notice, of durable material at least two (2) feet by four (4) feet in size, stating that "**Kentucky RSA #4 Cellular General Partnership proposes to construct a telecommunications tower near this site,**" including the addresses and telephone numbers of the applicant and the Kentucky Public Service Commission, has been posted on the public road nearest the site.

A copy of each sign is attached as Exhibit "H".

19. Pursuant to 807 KAR 5:063 § 1 (1)(q), a statement that notice of the location of the proposed construction has been published in a newspaper of general circulation in the county in which the construction is proposed is attached as Exhibit "I".

20. Pursuant to 807 KAR 5:063 § 1(1)(r), the cell site, which has been selected, is in a relatively undeveloped area in Magnolia, Kentucky.

21. Pursuant to 807 KAR 5:063 §1(1)(s), Kentucky RSA #4 has considered the likely effects of the installation on nearby land uses and values and has concluded that there is no more suitable location reasonably available from which adequate service to the area can be provided, and that there is no reasonably available opportunity to co-locate. Kentucky RSA #4 has attempted to co-locate on towers designed to host multiple wireless service providers' facilities or existing structures, such as a telecommunications tower, or another suitable structure capable of supporting the utility's facilities.

22. Pursuant to 807 KAR 5:063 § 1(1)(t), attached as Exhibit "J" is a map of the area in which the tower is proposed to be located, that is drawn to scale and that clearly depicts the search area in which a site should, pursuant to radio frequency requirements, be located.

23. Pursuant to KRS 100.987(2)(a), a grid map, that is drawn to scale, that shows the location of all existing cellular antenna towers and that indicates the general position of proposed construction sites for new cellular antenna towers is Exhibit "K".

24. No reasonably available telecommunications tower, or other suitable structure capable of supporting the cellular facilities of Kentucky RSA #4 Cellular and which would provide adequate service to the area exists.

25. Correspondence and communication with regard to this application should be addressed to:

John E. Selent
Holly C. Wallace
DINSMORE & SHOHL LLP
1400 PNC Plaza
500 West Jefferson Street
Louisville, KY 40202
(502) 540-2300
john.selent@dinslaw.com
holly.wallace@dinslaw.com

WHEREFORE, Kentucky RSA #4 Cellular General Cellular Partnership requests the Commission to enter an order:

1. Granting a certificate of public convenience and necessity to construct the Green North cell site; and
2. Granting all other relief as appropriate.

Respectfully submitted,



John E. Selent
Holly C. Wallace
DINSMORE & SHOHL LLP
1400 PNC Plaza
500 West Jefferson Street
Louisville, KY 40202
(502) 540-2300
john.selent@dinslaw.com
holly.wallace@dinslaw.com

LUKAS, NACE, GUTIERREZ & SACHS

CHARTERED

1650 TYSONS BOULEVARD, SUITE 1500
MCLEAN, VIRGINIA 22102
703 584 8678 • 703 584 8696 FAX

WWW.FCCLAW.COM

RUSSELL D. LUKAS
DAVID L. NACE
THOMAS GUTIERREZ*
ELIZABETH R. SACHS*
GEORGE L. LYON, JR.
PAMELA L. GIST
DAVID A. LAFURIA
TODD SLAMOWITZ*
B. LYNN F. RATNAVALE*
STEVEN M. CHERNOFF*
KATHERINE PATSAS*

CONSULTING ENGINEERS
ALI KUZEHKANANI
LEILA REZANAVAZ
OF COUNSEL
LEONARD S. KOLSKY*
JOHN CIMKO*
J. K. HAGE III*
JOHN J. MCAVOY*
HON. GERALD S. MCGOWAN*
TAMARA DAVIS-BROWN*

*NOT ADMITTED IN VA

December 12, 2007

Telephone
(703) 584-8668

Via Federal Express

Mr. John Houlihan
Kentucky Airport Zoning Commission
200 Mero Street
Frankfort, Kentucky 40622

Dear Mr. Houlihan:

Enclosed please find two completed TC 56-50 forms, Application for Permit to Construct or Alter a Structure, for a new tower (Green North) near Magnolia, Kentucky. The Structure, including top-mounted antennas will have an overall height of 255 feet Above Ground Level.

Enclosed Form TC 56-50 and the attached exhibit include all the pertinent information for this existing tower structure. Also enclosed are copies of the completed FAA Form 7460-1 for the proposed site, a non-reduced 7-1/2' U.S. Geological Survey map indicating the exact location of the site, and a 2-C survey report.

Please do not hesitate to contact the undersigned if there are questions regarding this matter.

Sincerely,



Leila Rezanavaz
Consulting Engineer

Enclosures

CC: Doug Updegraff

Kentucky Transportation Cabinet, Kentucky Airport Zoning Commission, 125 Holmes Street, Frankfort KY 40622

Kentucky Aeronautical Study Number

APPLICATION FOR PERMIT TO CONSTRUCT OR ALTER A STRUCTURE

1. APPLICANT - Name, Address, Telephone, Fax, etc.

Scott McCloud
Bluegrass Cellular
2902 Ring Road
Elizabethtown, KY 42702
Tel: 270-769-0339
Fax: 270-737-0580

9. Latitude: 37 ° 25 ' 41 " 03 "

10. Longitude: 85 ° 39 ' 31 " 79 "

11. Datum: NAD 83 NAD 27 Other

12. Nearest Kentucky City: Magnolia County: Larue

13. Nearest Kentucky public use or Military airport:
AAS- Taylor County Airport

14. Distance from #13 to Structure: 19.8 miles

15. Direction from #13 to Structure: WNW

16. Site Elevation (AMSL): 961 Feet

17. Total Structure Height (AGL): 255 Feet

18. Overall Height (#16 + #17) (AMSL): 1216 Feet

19. Previous FAA and/or Kentucky Aeronautical Study Number(s):
N/A

20. Description of Location: (Attach a USGS 7.5 minute Quadrangle Map or an Airport Layout Drawing with the precise site marked and any certified survey)

Site is located at:
788 Sand Ridge Road
Magnolia, KY 42757

2. Representative of Applicant - Name, Address, Telephone, Fax

Leila Rezanavaz
Lukas, Nace, Gutierrez & Sachs, Chartered
1650 Tysons Blvd., Suite 1500
McLean, VA 22102
T: 703-584-8668

3. Application for: New Construction Alteration Existing

4. Duration: Permanent Temporary (Months _____ Days _____)
2/10/08 2/15/08

5. Work Schedule: Start _____ End _____

6. Type: Antenna Tower Crane Building Power Line
 Landfill Water Tank Other _____

7. Marking/Painting and/or Lighting Preferred:

Red Lights and Paint Dual - Red & Medium Intensity White
 White - Medium Intensity Dual - Red & High Intensity White
 White - High Intensity Other _____

8. FAA Aeronautical Study Number 2007-AS0-7025-OE

21. Description of Proposal:

Structure: Tower with top-mounted antennas for overall height of 255' AGL.
ERP: 250 watts.
Frequencies: Cellular Band B

22. Has a "NOTICE OF CONSTRUCTION OR ALTERATION" (FAA Form 7460-1)

No

been filed with the Federal Aviation Administration?

Yes, When 12/11/07

CERTIFICATION: I hereby certify that all the above statements made by me are true, complete and correct to the best of my knowledge and belief.

Leila Rezanavaz/ Consulting Engineer Leila Rezanavaz 12/12/07

Printed Name Signature Date

PENALTIES: Persons failing to comply with Kentucky Revised Statutes (KRS 183.861 through 183.990) and Kentucky Administrative Regulations (602 KAR 050: Series) are liable for fines and/or imprisonment as set forth in KRS 183.990(3). Non-compliance with Federal Aviation Administration Regulations may result in further penalties.

Commission Action:

Chairman, KAZC

Administrator, KAZC


Approved

Disapproved

Date _____

Landmark Surveying Co., Inc.

Darren L. Helms, R.L.S., PRESIDENT
Dennis N. Helms, R.L.S., VICE PRESIDENT

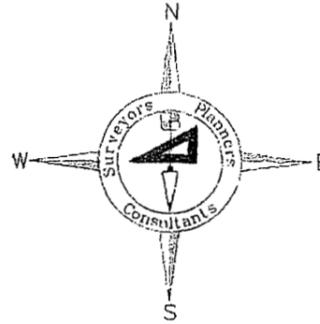

15 N.E. 3rd Street
Washington, Indiana 47501
Phone: 812-257-0950
Fax: 812-257-0953
E-mail: landmark@dmrtc.net

2C Certification

November 26, 2007

Designation: Green North
Site ID No.: Not Available
Tower Type: Proposed Self-Support Tower
Location: 788 Sand Ridge Road, Magnolia, KY 42757


I certify that the latitude, longitude, ground elevation and height of the proposed self-support tower are as follows:

Latitude:	37 degrees 25 minutes 41.03 seconds North	(NAD 1983)
Longitude:	85 degrees 39 minutes 31.79 seconds West	(NAD 1983)
Ground Elevation:	961.4 feet or 293.04 meters	(NAVD 1988)
Proposed Structure Height:	240 feet or 73.2 meters	(above ground level)
Proposed Overall Structure Height:	not available	(above ground level)

The accuracy of the latitude and longitude of the proposed self-support tower is ± 50 feet or ± 15 meters. The ground elevation and structure height are accurate to within ± 20 feet or ± 6 meter.

The information shown above is based upon field observations made on November 15, 2007 using the National Geodetic Survey monument "R 222" and the Kentucky State Plane Coordinate System, South Zone, NAD 1983 (2007). The field observations were completed using Sokkia GPS receivers and a Topcon GPT-8005A robotic total station. Geodetic computations were completed using Sokkia's Locus software and Autodesk Land Desktop 2007 software.

Landmark Surveying Co., Inc.

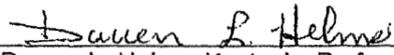
Darren L. Helms, Kentucky Professional Land Surveyor No. 3386



Notice of Proposed Construction or Alteration (7460-1)


Project Name: BLUEG-000084114-07 **Sponsor:** Bluegrass Cellular, Inc.

Details for Case : Green North

Show Project Summary

Case Status																					
ASN: 2007-ASO-7024-OE	Date Accepted: 12/11/2007																				
Status: Accepted	Date Determined:																				
	Letters: None																				
Construction / Alteration Information																					
Notice Of: Construction	Structure Summary																				
Duration: Permanent	Structure Type: Antenna Tower																				
<i>if Temporary :</i> Months: Days:	Structure Name: Green North																				
Work Schedule - Start: 02/10/2008	FCC Number:																				
Work Schedule - End: 02/15/2008	Prior ASN:																				
State Filing: Filed with State																					
Structure Details																					
Latitude: 37° 25' 41.03" N	Common Frequency Bands																				
Longitude: 85° 39' 31.79" W	<table border="1"> <thead> <tr> <th>Low Freq</th> <th>High Freq</th> <th>Freq Unit</th> <th>ERP</th> <th>ERP Unit</th> </tr> </thead> <tbody> <tr> <td>824</td> <td>849</td> <td>MHz</td> <td>500</td> <td>W</td> </tr> <tr> <td>851</td> <td>866</td> <td>MHz</td> <td>500</td> <td>W</td> </tr> <tr> <td>869</td> <td>894</td> <td>MHz</td> <td>500</td> <td>W</td> </tr> </tbody> </table>	Low Freq	High Freq	Freq Unit	ERP	ERP Unit	824	849	MHz	500	W	851	866	MHz	500	W	869	894	MHz	500	W
Low Freq	High Freq	Freq Unit	ERP	ERP Unit																	
824	849	MHz	500	W																	
851	866	MHz	500	W																	
869	894	MHz	500	W																	
Horizontal Datum: NAD83	Specific Frequencies																				
Site Elevation (SE): 961 (nearest foot)																					
Structure Height (AGL): 255 (nearest foot)																					
Marking/Lighting: Dual-red and medium intensity																					
<i>Other :</i>																					
Nearest City: Magnolia																					
Nearest State: Kentucky																					
Description of Location: 788 Sand Ridge Road Magnolia, KY 42757																					
Description of Proposal: Tower with top-mounted antennas for overall height of 255' AGL.																					

Section	T12	T11	T10	T9	T8	T7	T6	T5	T4	T3	T2	T1
Legs	SR 4 1/4	SR 4 1/4	SR 4	SR 3 3/4	SR 3 3/4	SR 3 1/2	SR 3 1/2	SR 3	SR 2 3/4	SR 2 1/2	SR 2 1/4	SR 1 3/4
Leg Grade	L3 1/2x3 1/2x1/4	L3 1/2x3 1/2x1/4	L3 3/4x1/4	L3 3/4x1/6	L3 3/4x1/6	L2 1/2x2 1/2x3/16	L2 1/2x2 1/2x3/16	L2 2x2x3/16	L1 3/4x1 3/4x3/16	L1 1/2x1 1/2x3/16	L1 1/2x1 1/2x3/16	L1 1/2x1 1/2x3/16
Diagonals												
Diagonal Grade												
Top Girts												
Face Width (ft)	17.5	17.5	14.5	11.5	11.5	10	8.5	7	5.5	20 @ 4.75	1.1	0.8
# Panels @ (ft)	4.9	4.8	4.1	3.6	3.2	2.7	2.6	2.0	1.6	1.3	1.1	0.8
Weight (K)	32.8											

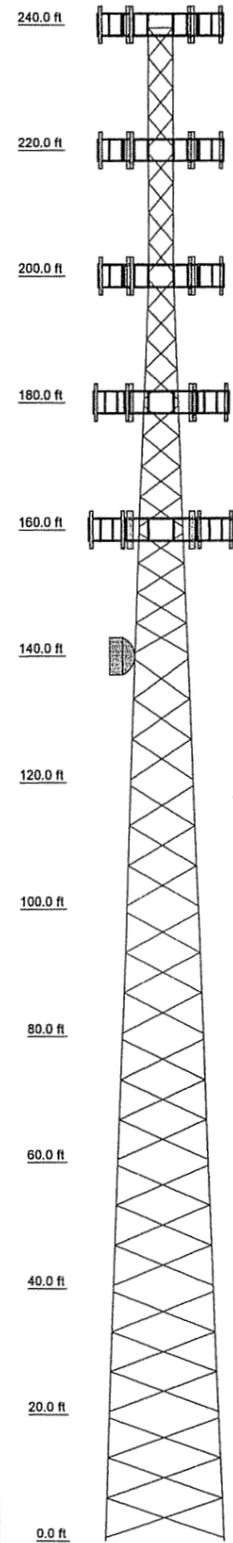

DESIGNED APPURTENANCE LOADING

TYPE	ELEVATION	TYPE	ELEVATION
(2) D100-0042-0041 (Initial)	240	T frame sector Mount (Future Carrier 2)	200
(2) D100-0042-0041 (Initial)	240		
(2) D100-0042-0041 (Initial)	240	(2) RWB 80014/120 (Future)	180
Lightning Rod 1"x10' (Initial)	240	(2) RWB 80014/120 (Future)	180
Flash Beacon Lighting (Initial)	240	(2) RWB 80014/120 (Future)	180
T frame sector Mount (Initial)	240	T frame sector Mount (Future Carrier 3)	180
T frame sector Mount (Initial)	240		
T frame sector Mount (Initial)	240	T frame sector Mount (Future Carrier 3)	180
(2) RWB 80014/120 (Future)	220	T frame sector Mount (Future Carrier 3)	180
(2) RWB 80014/120 (Future)	220		
(2) RWB 80014/120 (Future)	220	(2) RWB 80014/120 (Future)	160
T frame sector Mount (Future Carrier 1)	220	(2) RWB 80014/120 (Future)	160
T frame sector Mount (Future Carrier 1)	220	(2) RWB 80014/120 (Future)	160
(2) RWB 80014/120 (Future)	200	T frame sector Mount (Future Carrier 4)	160
(2) RWB 80014/120 (Future)	200		
(2) RWB 80014/120 (Future)	200	T frame sector Mount (Future Carrier 4)	160
T frame sector Mount (Future Carrier 2)	200		
T frame sector Mount (Future Carrier 2)	200	HP6-122	140

MATERIAL STRENGTH



GRADE	Fy	Fu	GRADE	Fy	Fu
A572-50	50 ksi	65 ksi	A36	36 ksi	58 ksi

TOWER DESIGN NOTES



1. Tower is located in Green County, Kentucky.
2. Tower designed for Exposure C to the TIA-222-G Standard.
3. Tower designed for a 90 mph basic wind in accordance with the TIA-222-G Standard.
4. Tower is also designed for a 30 mph basic wind with 0.75 in ice. Ice is considered to increase in thickness with height.
5. Deflections are based upon a 60 mph wind.
6. Tower designed as Structure Class II
7. In no case shall more than (6) lines be exposed to wind. Feedlines may be stacked in up to (2) rows on the inside and outside face of the tower.
8. Final Design 12/10/07. JLR

MAX. CORNER REACTIONS AT BASE:

DOWN: 426 K
 UPLIFT: -377 K
 SHEAR: 31 K

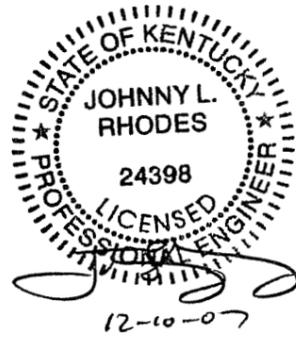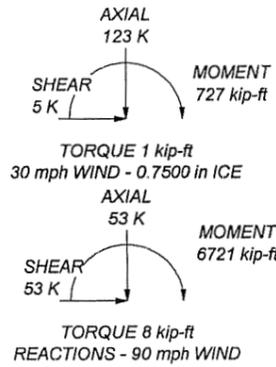


Eastpointe Engineering Group, LLC 4020 Tull Ave. Muskogee, OK 74403 Phone: 918.683.2169 FAX: 918.682.7618	Job: EII Job #2727--Green North
	Project: 240' SST/Green County, KY
	Client: Bluegrass Cellular Drawn by: Johnny L. Rhodes, P.E. App'd:
	Code: TIA-222-G Date: 12/10/07 Scale: NTS
	Path: Dwg No E-1

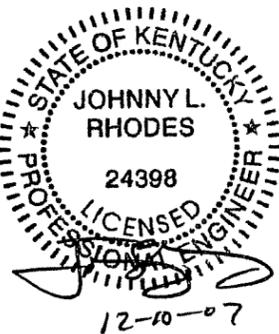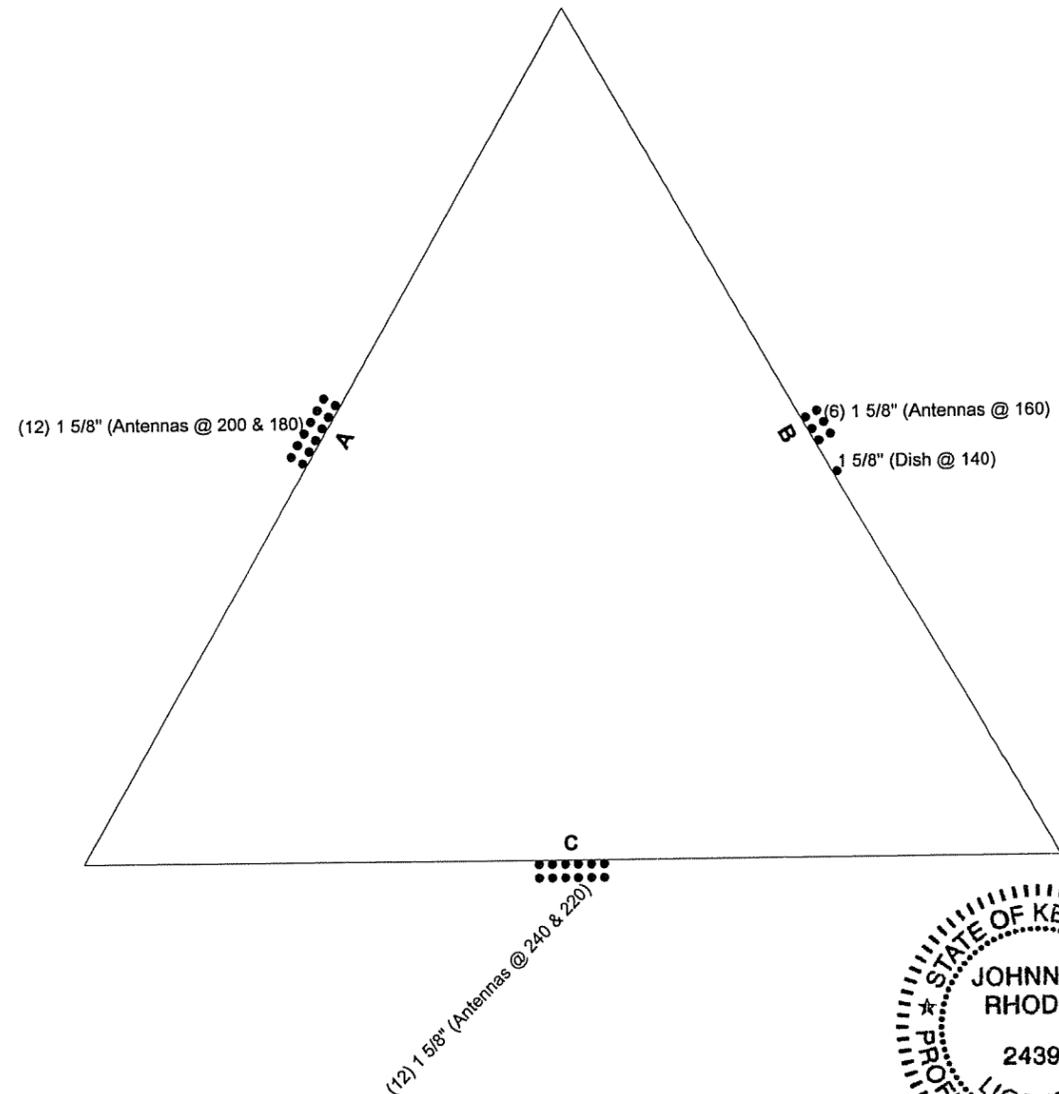

Eastpointe Engineering Group, LLC 4020 Tull Ave. Muskogee, OK 74403 Phone: 918.683.2169 FAX: 918.682.7618	Job: E11 Job #2727--Green North		
	Project: 240' SST/Green County, KY		
	Client: Bluegrass Cellular	Drawn by: Johnny L. Rhodes, P.E.	App'd:
	Code: TIA-222-G	Date: 12/10/07	Scale: NTS
	Path:	Dwg No E-7	


CAISSON DESIGN

Vertical Bars	(14) #9 bars, 40' long
Ties	#5 bars @ 6" c/c for the first 6.5' then 12" c/c thereafter

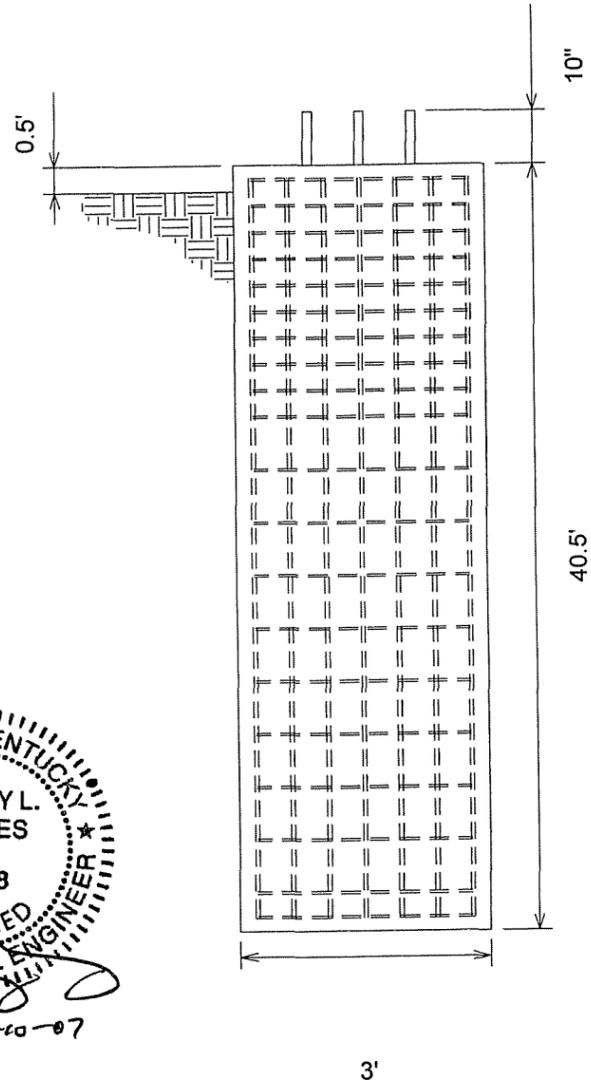

General Notes

1. Concrete shall be placed in accordance with ACI318-02, latest revision.
2. Concrete shall have a minimum 28 day compressive strength of 4000 PSI.
3. Rebar to conform to ASTM A615 grade 60.
4. Rebar used for ties may be A615 grade 40.
5. All rebar to have a minimum of 3" clear cover.
6. All exposed concrete corners to have 3/4" chamfer.
7. Bottom and side surfaces to rest on undisturbed soil.
8. Contractor shall be responsible to review and follow all recommendations of the geotechnical report.

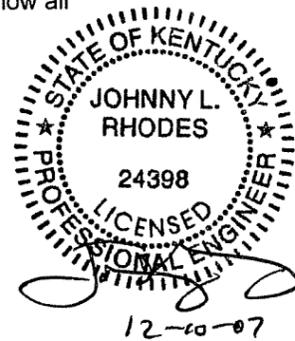

Supplemental Notes

Soil values obtained from Terracon soils report #57077384 Dated 12/05/07.
Use (6) 1 1/4" F1554 Grade 105 Anchor Bolts w/ min 60" embedment.

EASTPOINTE ENGINEERING GROUP, LLC
4020 Tull Ave. Muskogee, OK 74403--Phone 918.683.2169--Fax:918.682.7618

Client:	Bluegrass Cellular	
Site:	Green North	
Job:	2727	Drawn by: JLR
Scale:	NTS	Date: 12/10/07

GEOTECHNICAL ENGINEERING REPORT

**GREEN NORTH TELECOMMUNICATION TOWER
600 MOUNT SHERMAN-HART COUNTY LINE ROAD
MAGNOLIA, GREEN COUNTY, KENTUCKY**

**TERRACON PROJECT NO. 57077384
December 5, 2007**

Prepared For:

**BLUEGRASS CELLULAR PARTNERSHIP
Elizabethtown, Kentucky**

Prepared by:

Terracon
Louisville, Kentucky

Terracon

December 5, 2007

Bluegrass Cellular Partnership
2902 Ring Road
Elizabethtown, Kentucky 42702

Attention: Mr. Doug Updegraff

**Re: Geotechnical Engineering Report
Green North Telecommunication Tower
600 Mount Sherman-Hart County Line Road
Magnolia, Green County, Kentucky
Terracon Project No. 57077384**

Terracon
Consulting Engineers & Scientists

4545 Bishop Lane, Suite 101
Louisville, Kentucky 40218
Phone 502.456.1256
Fax 502.456.1278
www.terracon.com

Dear Mr. Updegraff:

The results of our subsurface exploration are attached. The purpose of this exploration was to obtain information on subsurface conditions at the proposed project site and, based on this information, to provide recommendations regarding the design and construction of the foundations for the proposed tower.


Terracon's geotechnical design parameters and recommendations within this report apply to the existing planned tower height and would apply to adjustments in the tower height, up to a 20% increase or decrease in height, as long as the type of tower does not change. If changes in the height of the tower dictate a change in tower type (ie - monopole to a self-support, self-support to a guyed tower), Terracon should be contacted to evaluate our recommendations with respect to these changes.

We appreciate the opportunity to be of service to you on this project. If you have any questions concerning this report, or if we may be of further service to you in any way, please feel free to contact us.

Sincerely,
Terracon



Shaikh Z. Rahman, EIT
Staff Engineer

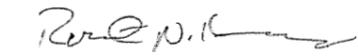

Robert N. Kennedy, P.E.
Kentucky No.: 23117

Copies: (4) Addressee



Timothy G. LaGrow, P.E.
Regional Manager

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GEOTECHNICAL ENGINEERING REPORT

**GREEN NORTH TELECOMMUNICATION TOWER
600 MOUNT SHERMAN-HART COUNTY LINE ROAD
MAGNOLIA, GREEN COUNTY, KENTUCKY
TERRACON PROJECT NO. 57077384
December 5, 2007**

1.0 INTRODUCTION

The purpose of this report is to describe the subsurface conditions encountered in the boring, analyze and evaluate the test data, and provide recommendations regarding the design and construction of the foundations and earthwork for the proposed tower. One boring extending to a depth of about 50½ feet below the existing ground surface was drilled at the site. An individual boring log and a boring location plan are included with this report.

2.0 PROJECT DESCRIPTION

Terracon understands the proposed project will consist of the construction of a 240-foot self supporting lattice tower. Exact tower loads are not available, but based on our past experience are anticipated to be as follows:

Vertical Load:	600 kips
Horizontal Shear:	80 kips
Uplift:	500 kips

A small, lightly loaded equipment building will also be constructed. Wall and floor loads for this building are not anticipated to exceed 1 kip per linear foot and 100 pounds per square foot, respectively. The subject site consists of an approximate 100- by 100-foot parcel of relatively level, partially wooded land located east of Mt. Sherman-Hart County Line Road in Magnolia, Green County, Kentucky. Existing grades at the site were not available as of this writing. Based on the provided drawing and site information, the approximate elevation at the center of tower is EL 970. Based on observed topography, minimal cut/fill can be anticipated to level the site for construction.

3.0 EXPLORATION PROCEDURES

3.1 Field Exploration

The subsurface exploration consisted of drilling and sampling one boring at the site to a depth of about 50½ feet below existing grade. The boring was advanced approximately 10 feet west of the center of the tower, as staked by the project surveyor. The location of the boring should be considered accurate only to the degree implied by the means and methods used to define them.

The boring was drilled with a truck-mounted rotary drill rig using hollow stem augers to advance the borehole. Representative soil samples were obtained by the split-barrel sampling procedure in general accordance with the appropriate standard. In the split-barrel sampling procedure, the number of blows required to advance a standard 2-inch O.D. split-barrel sampler the last 12 inches of the typical total 18-inch penetration by means of a 140-pound hammer with a free fall of 30 inches, is the standard penetration resistance (SPT) value (N-Value). This value is used to estimate the in-situ relative density of cohesionless soils and the consistency of cohesive soils. The sampling depths, penetration distance, and SPT N-Values are shown on the boring log. The samples were sealed and delivered to the laboratory for testing and classification.

Due to limited recovery in some split spoon samples, rock coring was attempted to sample the weathered bedrock between the depths of 8 ½ to 18 ½ feet. Due to the apparent degree of weathering, no samples were recovered using this technique and the remaining profile below this depth was sampled using the split barrel procedure.

A field log of the boring was prepared by a subcontract driller. This log included visual classifications of the materials encountered during drilling as well as the driller's interpretation of the subsurface conditions between samples. The final boring log included with this report represents an interpretation of the driller's field log and a visual classification of the soil samples made by the Geotechnical Engineer.

3.2 Laboratory Testing

The samples were classified in the laboratory based on visual observation, texture and plasticity. The descriptions of the soils indicated on the boring log are in accordance with the enclosed General Notes and the Unified Soil Classification System. Estimated group symbols according to the Unified Soil Classification System are given on the boring log. A brief description of this classification system is attached to this report.

The laboratory testing program consisted of performing water content tests and an Atterberg Limits test on representative soil samples. Information from these tests was used in conjunction with field penetration test data to evaluate soil strength in-situ, volume change potential, and soil classification. Results of these tests are provided on the boring log.

4.0 EXPLORATORY FINDINGS

4.1 Subsurface Conditions

Conditions encountered at the boring location are indicated on the boring log. Stratification boundaries on the boring log represent the approximate location of changes in soil types and the transition between materials may be gradual. Water levels shown on the boring log

represent the conditions only at the time of our exploration. Based on the results of the boring, subsurface conditions on the project site can be generalized as follows.

Beneath about 0.3 foot of topsoil, the boring encountered sandy silt (ML) and sandy clay (CL) to a depth of about 5 feet below grade where the soil profile transitioned into sand and weathered sandstone extending to planned boring termination depth of about 50½ feet below grade. The sandy silt and clay exhibited a medium stiff to very stiff consistency based on standard penetration test (N) values of 5 and 34 blows per foot. The underlying sand and weathered sandstone was very dense based on N-values of over 50 bpf.

4.2 Site Geology

A review of the Geologic Map of the Magnolia Quadrangle published by the United States Geological Survey (USGS) indicates that the site is underlain by the Saint Genevieve and Saint Louis Limestones of the Mississippian age. The Saint Genevieve and Saint Louis Limestones are comprised by limestone, dolomite and shale and can range up to 240 feet thick. Sand, clay and gravel derived from slumped sandstone, shale and conglomerate are encountered in some areas within this quadrangle. Although not mapped at this site, the results of our boring would indicate the presence of these materials.

It should be noted that the site is underlain by a limestone formation that is highly susceptible to dissolution along joints and bedding planes in the rock mass. This results in voids and solution channels within the rock strata and a highly irregular bedrock surface. The weathering of the bedrock and subsequent collapse or erosion of the overburden into these openings results in what is referred to as a karst topography. Any construction in karst topography is accompanied by some degree of risk for future internal soil erosion and ground subsidence that could affect the stability of the proposed structures. Our review of the available topographic and geologic mapping did not note any sinkholes on or around the site, or within a ½ mile radius of the property. Furthermore, the borings drilled at the site did not disclose any obvious signs of impending overburden collapse.

4.3 Groundwater Conditions

The boring was monitored while drilling and immediately after completion for the presence and level of groundwater. Water levels observed in the boring are noted on the boring log. After completion of drilling operations, groundwater was observed in the boring at a depth of about 39 feet below existing grade. However, it should be recognized that water was used during the rock coring procedures. Therefore, these water level observations only provide an approximate indication of the groundwater conditions existing on the site at the time the boring was drilled. Longer term monitoring in cased holes or piezometers would be required for a more accurate evaluation of the groundwater conditions.

It should be recognized that fluctuations of the groundwater table may occur due to seasonal variations in the amount of rainfall, runoff and other factors not evident at the time the boring was performed. Therefore, groundwater levels during construction or at other times in the life of the structure may be higher or lower than the levels indicated on the boring log. The possibility of groundwater level fluctuations should be considered when developing the design and construction plans for the project.

5.0 ENGINEERING RECOMMENDATIONS

Based on the encountered subsurface conditions, the tower can be constructed on drilled piers or on a mat foundation. The lightly loaded equipment building can be supported on shallow spread footings. Drilled pier and shallow foundation recommendations are presented in the following paragraphs.

5.1 Tower Foundation

Drilled Pier Alternative: Based on the results of the boring, the following tower foundation design parameters have been developed:

Table 1 - Drilled Pier Foundation Design Parameters

Depth * (feet)	Description **	Allowable Skin Friction (psf)	Allowable End Bearing Pressure (psf)	Allowable Passive Pressure (psf)	Internal Angle of Friction (Degree)	Cohesion (psf)	Lateral Subgrade Modulus (pci)	Strain, & ₅₀ (in/in)
0 - 3	Topsoil and Sandy Silt	Ignore	Ignore	Ignore	-	-	Ignore	Ignore
3 - 5	Sandy Clay	250	3,000	1,000	0	1,500	125	0.007
3 - 25	Sand and Weathered Sandstone	250 - 900 ***	5,000 ***	1,000 - 5,000 ***	34	0	225	0.001
25 - 50	Sand and Weathered Sandstone	1,000	7,000 ***	5,000 - 10,000 ***	36	0	225	0.001

* Pier inspection is recommended to adjust pier length if variable soil/rock conditions are encountered.

** A total unit weight of 120 pcf and 130 pcf can be assumed for the clays and sands respectively. The buoyant unit weight of sand can be taken as 63 pcf.

*** Increases linearly. Skin friction values for sands assume uplift controls design. Compression skin friction values for sands can be increased by 50%, if necessary.

The above indicated cohesion, friction angle, lateral subgrade modulus and strain values have no factors of safety, and the allowable skin friction and the passive resistances have factors of safety of 2. The cohesion, internal friction angle, lateral subgrade modulus and strain values given in the above table are based on the boring, published correlation values and Terracon's past experience with similar soil/rock types. These values should, therefore, be considered approximate. The allowable end bearing pressure provided in the table has an approximate factor of safety of at least 3. Total settlement of drilled piers designed using the above parameters is not anticipated to exceed 1 inch.

The upper 3 feet of topsoil, sandy silt and clay should be ignored due to the potential affects of frost action and construction disturbance. To avoid a reduction in lateral and uplift resistance caused by variable subsurface conditions, we recommend that drawings instruct the contractor to notify the engineer if subsurface conditions significantly different than those encountered in the boring are disclosed during the drilled pier installations. Under these circumstances, it may be necessary to adjust the overall length of the pier. To facilitate these adjustments and assure that the pier is embedded in suitable materials, it is recommended that a Terracon representative observe the drilled pier excavations.

Although the boring was able to penetrate the highly weathered sandstone, there is a possibility that larger diameter drilled pier equipment will refuse on this material. The contractor should recognize the hardness of the material and be prepared to use rock teeth or other means to extend through these layers.

A drilled pier foundation should be designed with a minimum shaft diameter of 30 inches to facilitate clean out and possible dewatering of the pier excavation. Temporary casing may be required during the pier excavation in order to control possible groundwater seepage and support the sides of the excavation in weak soil zones. Care should be taken so that the sides and bottom of the excavations are not disturbed during construction. The bottom of the shaft should be free of loose soil or debris prior to reinforcing steel and concrete placement.

A concrete slump of at least 6 inches is recommended to facilitate temporary casing removal. It should be possible to remove the casing from a pier excavation during concrete placement provided that the concrete inside the casing is maintained at a sufficient level to resist any earth and hydrostatic pressures outside the casing during the entire casing removal procedure.

Mat Foundation Alternative: The mat foundation can be designed using the following natural soil/engineered fill parameters. These parameters are based on the findings of the boring, a review of published correlation values and Terracon's experience with similar soil conditions. These design parameters also assume that the base of the mat foundation will rest on natural soils or well-graded crushed stone that is compacted and tested on a full time basis.

Mat Foundation Design Parameters

Depth (feet)	Description	Allowable Contact Bearing Pressure (psf)	Allowable Passive Pressure (psf)	Coefficient of Friction, Tan δ	Vertical Modulus of Subgrade Reaction (pci)
0 - 4	Topsoil and Sandy Silt	Ignore	Ignore	-	
≥ 4	Weathered Sandstone or Crushed Stone Fill	5,000	Ignore	0.5	150

To assure that soft soils are not left under the mat foundation, it is recommended that a geotechnical engineer observe the foundation subgrade prior to concrete placement. Provided the above recommendations are followed, total mat foundation settlements are not anticipated to exceed about 1 inch. Differential settlement should not exceed 50 percent of the total settlement.

5.2 Equipment Building Foundations

The proposed equipment shed may be supported on shallow footings bearing on stiff natural soils. The equipment building foundations should be dimensioned using a net allowable soil bearing pressure of 2,000 pounds per square foot (psf). In using net allowable soil pressures for footing dimensioning, the weight of the footings and backfill over the footings need not be considered. Furthermore, the footings should be at least 12 inches wide and a minimum of 2 feet square.

The geotechnical engineer or a qualified representative should observe the foundation excavations to verify that the bearing materials are suitable for support of the proposed loads. If, at the time of such observation, any soft soils are encountered at the design foundation elevation, the excavations should be extended downward so that the footings rest on stiff soils. If it is inconvenient to lower the footings, the proposed footing elevations may be re-established by backfilling after the undesirable material has been removed.

The recommended soil bearing value should be considered an upper limit, and any value less than that listed above would be acceptable for the foundation system. Using the value given, total settlement would be about 1 inch or less with differential settlements being less than 75 percent of total settlement. Footings should be placed at a depth of 2 feet, or greater, below finished exterior grade for protection against frost damage.

5.3 Parking and Drive Areas

The drive that accesses the site will be surfaced with crushed stone. Parking and drive areas that are surfaced with crushed stone should have a minimum thickness of 6 inches and be properly placed and compacted as outlined herein. The crushed stone should meet Kentucky Transportation Cabinet specifications and applicable local codes.

A paved section consisting only of crushed graded aggregate base course should be considered a high maintenance section. Regular care and maintenance is considered essential to the longevity and use of the section. Site grades should be maintained in such a manner as to allow for adequate surface runoff. Any potholes, depressions or excessive rutting that may develop should be repaired as soon as possible to reduce the possibility of degrading the soil subgrade.

5.4 Site Preparation

Site preparation should begin with the removal of any topsoil, loose, soft or otherwise unsuitable materials from the construction area. The geotechnical engineer should evaluate the actual stripping depth, along with any soft soils that require undercutting at the time of construction.

Any fill and backfill placed on the site should consist of approved materials that are free of organic matter and debris. Suitable fill materials should consist of well graded crushed stone below the tower foundation and well graded crushed stone or low plasticity cohesive soil elsewhere. Low-plasticity cohesive soil should have a liquid limit of less than 45 percent and a plasticity index of less than 25 percent. The on site soils are considered suitable for re-use as fill. It is recommended that during construction these soils should be further tested and evaluated prior to use as fill. Fill should not contain frozen material and it should not be placed on a frozen subgrade.

The fill should be placed and compacted in lifts of 9 inches or less in loose thickness. Fill placed below structures or used to provide lateral resistance should be compacted to at least 95 percent of the material's maximum standard Proctor dry density (ASTM D-698). Fill should be placed, compacted, and maintained at moisture contents within minus 2 to plus 2 percent of the optimum value determined by the standard Proctor test.

The geotechnical engineer should be retained to monitor fill placement on the project and to perform field density tests as each lift of fill is placed in order to evaluate compliance with the design requirements. Standard Proctor and Atterberg limits tests should be performed on the representative samples of fill materials before their use on the site.

6.0 GENERAL COMMENTS

Terracon should be retained to review the final design plans and specifications so comments can be made regarding interpretation and implementation of our geotechnical recommendations in the design and specifications. Terracon also should be retained to provide testing and observation during excavation, grading, foundation and construction phases of the project.

The analysis and recommendations presented in this report are based upon the data obtained from the boring performed at the indicated location and from other information discussed in this report. This report does not reflect variations that may occur across the site, or due to the modifying effects of weather. The nature and extent of such variations may not become evident until during or after construction. If variations appear, we should be immediately notified so that further evaluation and supplemental recommendations can be provided.


Green North Telecommunication Tower
Magnolia, Kentucky
Terracon Project No.: 57077348
December 5, 2007



The scope of services for this project does not include either specifically or by implication any environmental or biological (e.g., mold, fungi, bacteria) assessment of the site or identification or prevention of pollutants, hazardous materials or conditions. If the owner is concerned about the potential for such contamination or pollution, other studies should be undertaken.

This report has been prepared for the exclusive use of our client for specific application to the project discussed and has been prepared in accordance with generally accepted geotechnical engineering practices. No warranties, either express or implied, are intended or made. Site safety, excavation support, and dewatering requirements are the responsibility of others. In the event that changes in the nature, design, or location of the project as outlined in this report are planned, the conclusions and recommendations contained in this report shall not be considered valid unless Terracon reviews the changes and either verifies or modifies the conclusions of this report in writing.

APPENDIX

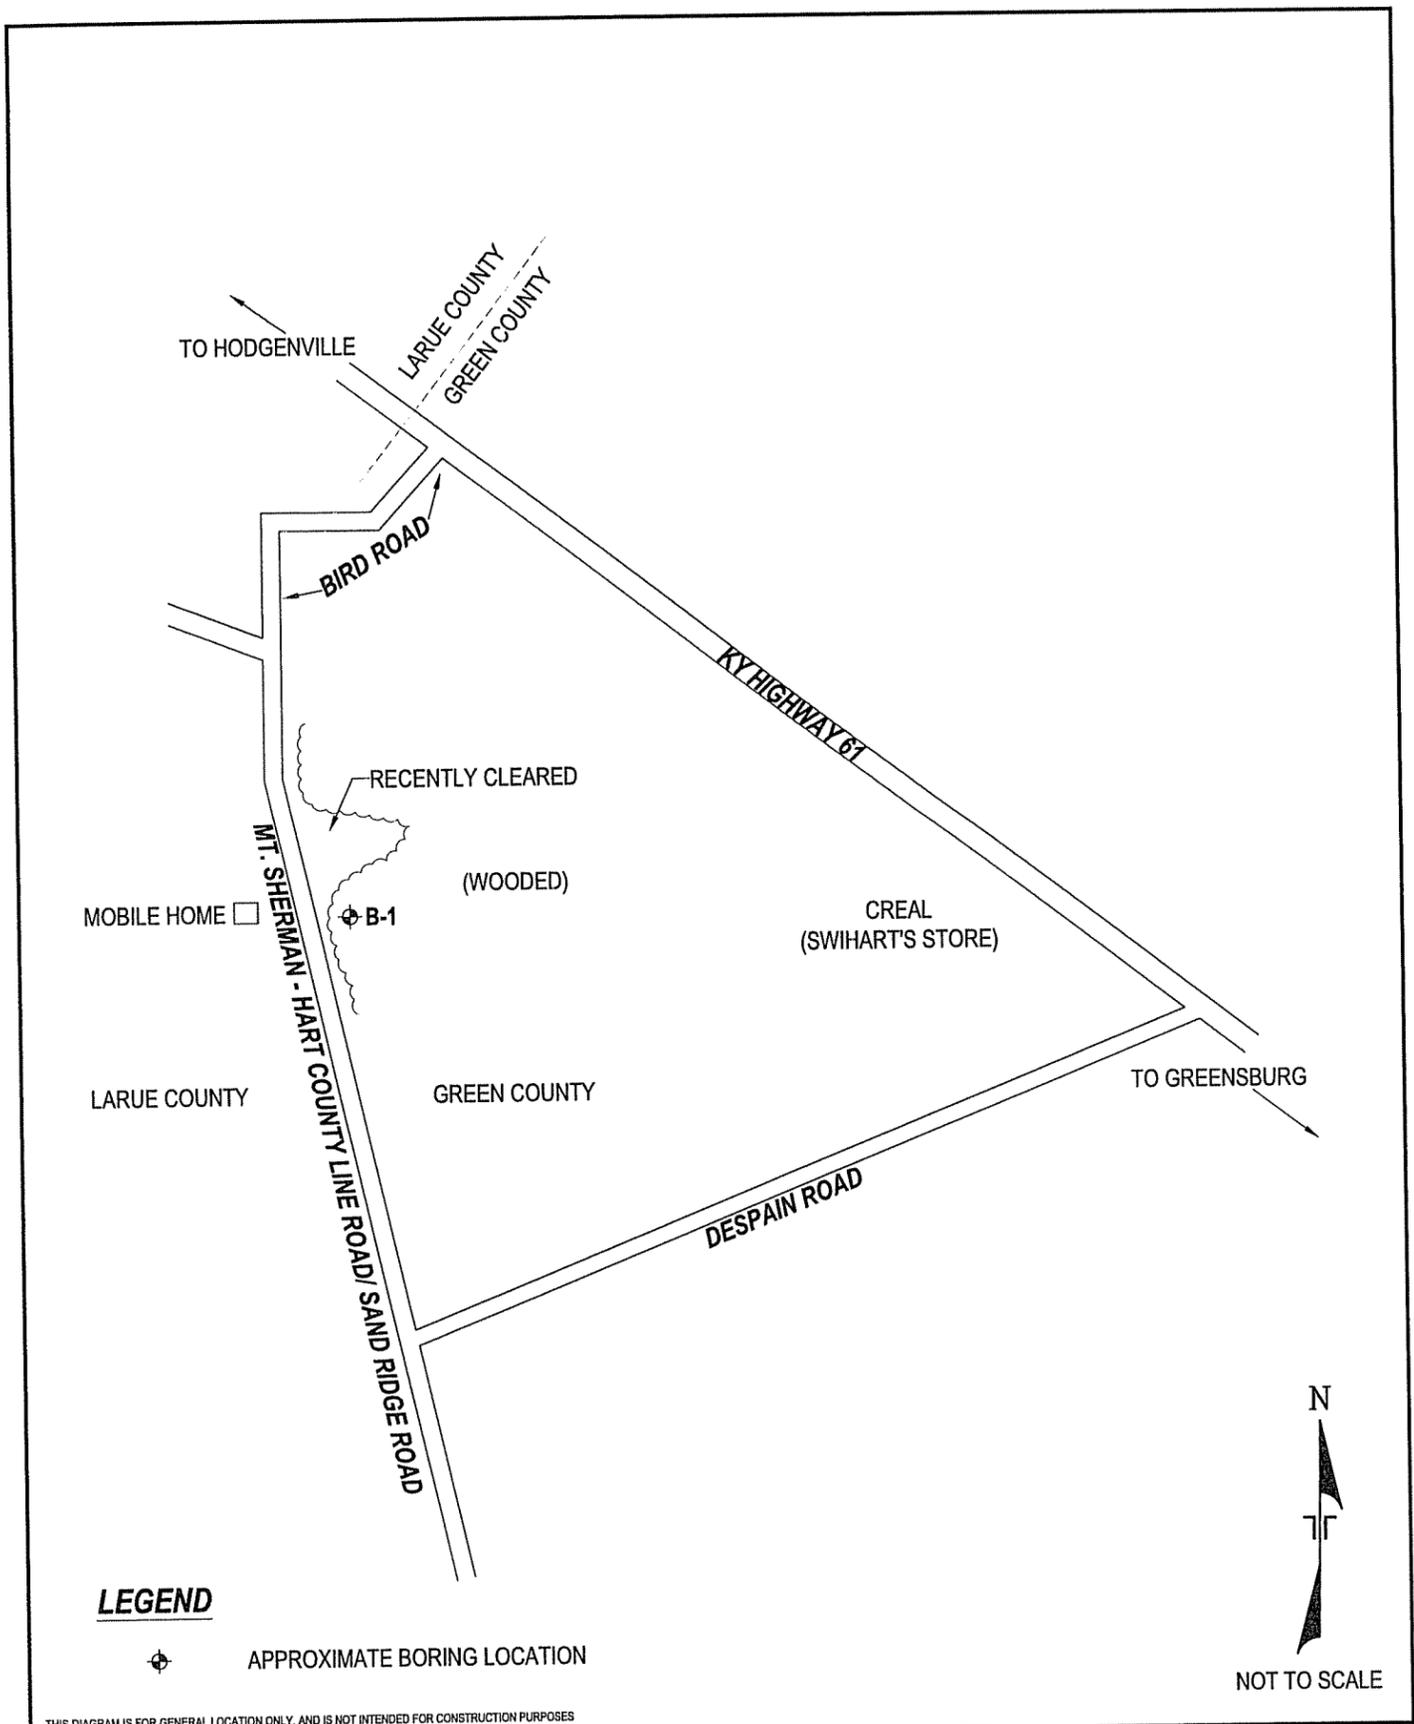

Project Mgr:	TMH	Project No.	57077384	Terracon Consulting Engineers and Scientists 4545 Bishop Lane, Suite 101 Louisville, KY 40218 (502) 456-1256 (502) 456-1278	BORING LOCATION DIAGRAM GEOTECHNICAL ENGINEERING REPORT GREEN NORTH 600 MOUNT SHERMAN-HART Co. LINE ROAD MAGNOLIA, KY 42757	FIG. No.
Drawn By:	DWD	Scale:	AS SHOWN			1
Checked By:	TMH/MRF	File No.	GEO57077384-1			
Approved By:	EH	Date:	NOV. 2007			

LOG OF BORING NO. B-1

CLIENT
Bluegrass Cellular Partnership
 SITE600 Mount Sherman Hart County Line Road
 Magnolia, Kentucky

PROJECT
Proposed Green North Telecommunication Tower

GRAPHIC LOG	DEPTH, ft.	USCS SYMBOL	SAMPLES				TESTS			ATTERBERG LIMITS
			NUMBER	TYPE	RECOVERY, in.	SPT - N BLOWS / ft.	WATER CONTENT, %	DRY UNIT WT pcf	UNCONFINED STRENGTH, psf	
	2	ML	1	SS	12	5	17			LL = 27 PL = 15 PI = 12
	2	CL	2	SS	8	34	16			
	5	SP	3	SS	8	20				
	5	SP	4	SS	3	50/3				
	10	SP	5	DB	0%	RQD 0%				
	20	SP	6	SS	18	54				
	25	SP	7	SS	5	50/5				
	30	SP	8	SS	4	50/4				
	35	SP	9	SS	5	50/5				
	40	SP	10	SS	5	50/5				
	45	SP	11	SS	5	50/5				
	50	SP	12	SS	18	66				
50.5		Boring Terminated at 50.5 feet								

BOREHOLE 99 57077384 LOGS.GPJ TERRACON.GDT 12/5/07

The stratification lines represent the approximate boundary lines between soil and rock types: in-situ, the transition may be gradual.

WATER LEVEL OBSERVATIONS, ft		
WL	▽ 39.0	AB ▽
WL	▽	▽
WL		



BORING STARTED	11-8-07
BORING COMPLETED	11-9-07
RIG Mobile B-34	FOREMAN TS
APPROVED TMH	JOB # 57077384

GENERAL NOTES

DRILLING & SAMPLING SYMBOLS:

SS:	Split Spoon - 1-3/8" I.D., 2" O.D., unless otherwise noted	HS:	Hollow Stem Auger
ST:	Thin-Walled Tube - 2" O.D., unless otherwise noted	PA:	Power Auger
RS:	Ring Sampler - 2.42" I.D., 3" O.D., unless otherwise noted	HA:	Hand Auger
DB:	Diamond Bit Coring - 4", N, B	RB:	Rock Bit
BS:	Bulk Sample or Auger Sample	WB:	Wash Boring or Mud Rotary

The number of blows required to advance a standard 2-inch O.D. split-spoon sampler (SS) the last 12 inches of the total 18-inch penetration with a 140-pound hammer falling 30 inches is considered the "Standard Penetration" or "N-value".

WATER LEVEL MEASUREMENT SYMBOLS:

WL:	Water Level	WS:	While Sampling	N/E:	Not Encountered
WCI:	Wet Cave in	WD:	While Drilling		
DCI:	Dry Cave in	BCR:	Before Casing Removal		
AB:	After Boring	ACR:	After Casing Removal		

Water levels indicated on the boring logs are the levels measured in the borings at the times indicated. Groundwater levels at other times and other locations across the site could vary. In pervious soils, the indicated levels may reflect the location of groundwater. In low permeability soils, the accurate determination of groundwater levels may not be possible with only short-term observations.

DESCRIPTIVE SOIL CLASSIFICATION: Soil classification is based on the Unified Classification System. Coarse Grained Soils have more than 50% of their dry weight retained on a #200 sieve; their principal descriptors are: boulders, cobbles, gravel or sand. Fine Grained Soils have less than 50% of their dry weight retained on a #200 sieve; they are principally described as clays if they are plastic, and silts if they are slightly plastic or non-plastic. Major constituents may be added as modifiers and minor constituents may be added according to the relative proportions based on grain size. In addition to gradation, coarse-grained soils are defined on the basis of their in-place relative density and fine-grained soils on the basis of their consistency.

CONSISTENCY OF FINE-GRAINED SOILS

<u>Unconfined Compressive Strength, Qu, psf</u>	<u>Standard Penetration or N-value (SS) Blows/Ft.</u>	<u>Consistency</u>
< 500	<2	Very Soft
500 – 1,000	2-4	Soft
1,001 – 2,000	5-7	Medium Stiff
2,001 – 4,000	8-15	Stiff
4,001 – 8,000	16-30	Very Stiff
8,000+	30+	Hard

RELATIVE DENSITY OF COARSE-GRAINED SOILS

<u>Standard Penetration or N-value (SS) Blows/Ft.</u>	<u>Relative Density</u>
0 – 3	Very Loose
4 – 9	Loose
10 – 29	Medium Dense
30 – 49	Dense
50+	Very Dense

RELATIVE PROPORTIONS OF SAND AND GRAVEL

<u>Descriptive Term(s) of other constituents</u>	<u>Percent of Dry Weight</u>
Trace	< 15
With	15 – 29
Modifier	> 30

GRAIN SIZE TERMINOLOGY

<u>Major Component of Sample</u>	<u>Particle Size</u>
Boulders	Over 12 in. (300mm)
Cobbles	12 in. to 3 in. (300mm to 75 mm)
Gravel	3 in. to #4 sieve (75mm to 4.75 mm)
Sand	#4 to #200 sieve (4.75mm to 0.075mm)
Silt or Clay	Passing #200 Sieve (0.075mm)

RELATIVE PROPORTIONS OF FINES

<u>Descriptive Term(s) of other constituents</u>	<u>Percent of Dry Weight</u>
Trace	< 5
With	5 – 12
Modifiers	> 12

PLASTICITY DESCRIPTION

<u>Term</u>	<u>Plasticity Index</u>
Non-plastic	0
Low	1-10
Medium	11-30
High	30+

UNIFIED SOIL CLASSIFICATION SYSTEM

Criteria for Assigning Group Symbols and Group Names Using Laboratory Tests^A

			Soil Classification		
			Group Symbol	Group Name ^B	
Coarse Grained Soils More than 50% retained on No. 200 sieve	Gravels More than 50% of coarse fraction retained on No. 4 sieve	Clean Gravels Less than 5% fines ^C	$Cu \geq 4$ and $1 \leq Cc \leq 3^E$	GW	Well-graded gravel ^F
		Gravels with Fines More than 12% fines ^C	Fines classify as ML or MH Fines classify as CL or CH	GP GM GC	Poorly graded gravel ^F Silty gravel ^{F,G,H} Clayey gravel ^{F,G,H}
	Sands 50% or more of coarse fraction passes No. 4 sieve	Clean Sands Less than 5% fines ^D	$Cu \geq 6$ and $1 \leq Cc \leq 3^E$ $Cu < 6$ and/or $1 > Cc > 3^E$	SW SP	Well-graded sand ^I Poorly graded sand ^I
		Sands with Fines More than 12% fines ^D	Fines classify as ML or MH	SM	Silty sand ^{G,H,I}
			Fines Classify as CL or CH	SC	Clayey sand ^{G,H,I}
		Fine-Grained Soils 50% or more passes the No. 200 sieve	Silt and Clays Liquid limit less than 50	inorganic	$PI > 7$ and plots on or above "A" line ^J $PI < 4$ or plots below "A" line ^J
organic	Liquid limit - oven dried < 0.75			OL	Organic clay ^{K,L,M,N}
	Liquid limit - not dried				Organic silt ^{K,L,M,O}
Silt and Clays Liquid limit 50 or more	inorganic			PI plots on or above "A" line PI plots below "A" line	CH MH
	organic		Liquid limit - oven dried < 0.75	OH	Organic clay ^{K,L,M,P}
			Liquid limit - not dried		Organic silt ^{K,L,M,Q}
	Highly organic soils		Primarily organic matter, dark in color, and organic odor		PT

^ABased on the material passing the 3-in. (75-mm) sieve

^BIf field sample contained cobbles or boulders, or both, add "with cobbles or boulders, or both" to group name.

^CGravels with 5 to 12% fines require dual symbols: GW-GM well-graded gravel with silt, GW-GC well-graded gravel with clay, GP-GM poorly graded gravel with silt, GP-GC poorly graded gravel with clay.

^DSands with 5 to 12% fines require dual symbols: SW-SM well-graded sand with silt, SW-SC well-graded sand with clay, SP-SM poorly graded sand with silt, SP-SC poorly graded sand with clay

$$E \quad Cu = D_{60}/D_{10} \quad Cc = \frac{(D_{30})^2}{D_{10} \times D_{60}}$$

^FIf soil contains $\geq 15\%$ sand, add "with sand" to group name.

^GIf fines classify as CL-ML, use dual symbol GC-GM, or SC-SM.

^HIf fines are organic, add "with organic fines" to group name.

^IIf soil contains $\geq 15\%$ gravel, add "with gravel" to group name.

^JIf Atterberg limits plot in shaded area, soil is a CL-ML, silty clay.

^KIf soil contains 15 to 29% plus No. 200, add "with sand" or "with gravel," whichever is predominant.

^LIf soil contains $\geq 30\%$ plus No. 200 predominantly sand, add "sandy" to group name.


^MIf soil contains $\geq 30\%$ plus No. 200, predominantly gravel, add "gravelly" to group name.

^N $PI \geq 4$ and plots on or above "A" line.

^O $PI < 4$ or plots below "A" line.

^P PI plots on or above "A" line.

^Q PI plots below "A" line.

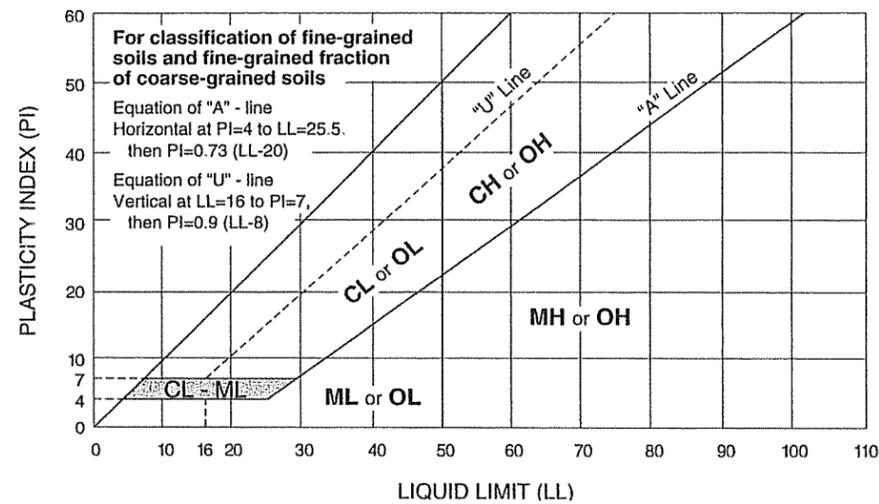

Site: Green North Lease Boundary and Topographic Survey Green County, Kentucky



Basis of Bearings

The bearing system of this survey is based upon G.P.S. observations made on November 15, 2007 using the National Geodetic Survey monument "R 222" and the Kentucky State Plane Coordinate System, South Zone, NAD 1983 (2007). This system is grid north.

Tower Location Information

Designation: Green North
Site ID#: None
Horizontal Datum: NAD 1983 (2007)
Latitude: 37°25'41.03" North
Longitude: 85°39'31.79" West
Vertical Datum: NAVD 1988
Ground Elevation: 961.4 feet (293.04 meters)
State Plane Coordinates:
Northing: 2,039,008.58 feet (621,491.058 meters)
Easting: 1,666,889.75 feet (508,069.012 meters)

Owner Information

Owners: Floyd Evans and Sandra Evans
Address: 600 Mt. Sherman-Ward Road
Magnolia, Kentucky 42757
Contact Person: Floyd Evans
Phone: (270) 325-3054
PVA Map No. 10-34


Project Bench Mark

Northing: 2,039,013 feet (621,492 meters)
Easting: 1,666,763 feet (508,030 meters)
Elevation: 969.91 feet (295.629 meters)
Description: A railroad spike set in the north side of a utility pole, 12" above grade. The pole is located on the west side of Sand Ridge Road about 125' west of the center of the tower.

Flood Plain Statement


According to the FEMA web site, this is an unmapped area. No flood information is available for the unincorporated areas of Green County, Kentucky. However, a visual inspection of the site would indicate that the subject site does not lie within a flood prone area.

Vicinity Map

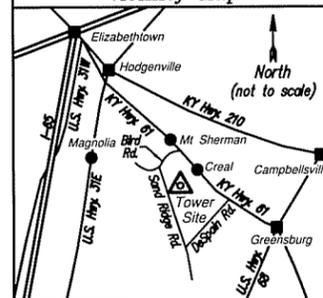

Directions to Site

From the intersection of U.S. Highway 31W and Kentucky Highway 61 on the south side of Elizabethtown, Kentucky, travel southeasterly on Kentucky Highway 61, passing through Hodgenville and Mt. Sherman, for 20.5 miles to Bird Road at the LaRue/Green County Line; turn right onto Bird Road and travel southerly for 0.5 miles to Sand Ridge Road; continue southerly on Sand Ridge Road for 0.8 miles to the tower site on the left or east side of the road in a wooded area.

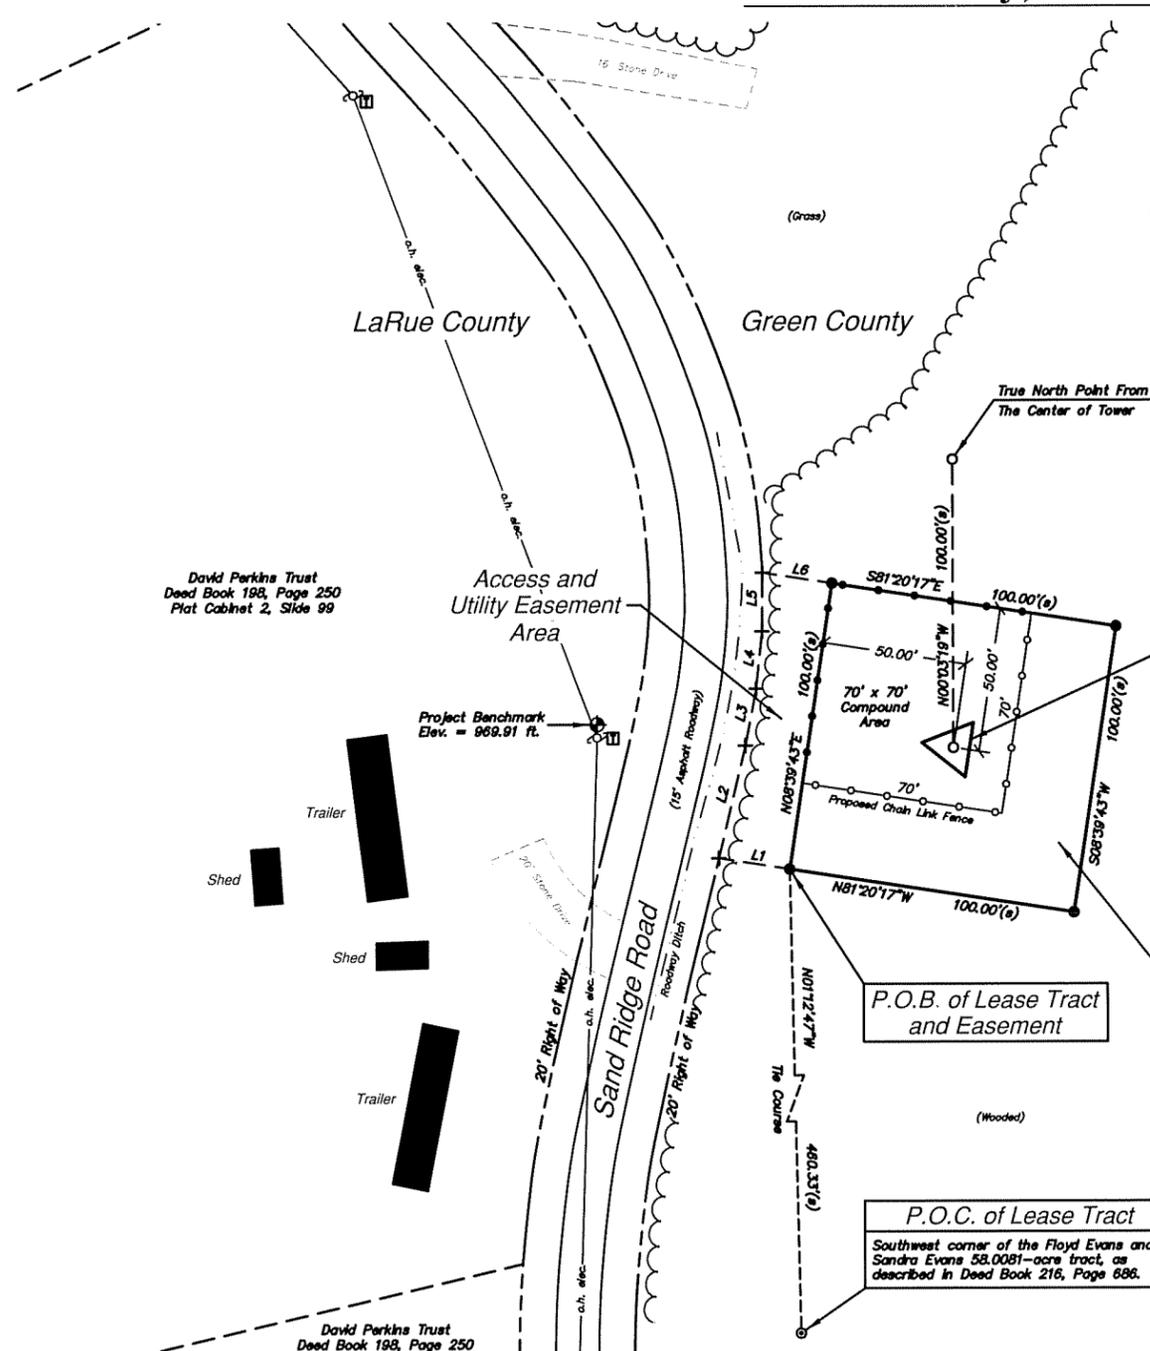

Course	Bearing	Length
L1	N81°20'17"W	25.00'(c)
L2	N13°32'10"E	40.00'(c)
L3	N10°59'53"E	20.00'(c)
L4	N06°11'02"E	20.00'(c)
L5	N00°22'38"E	20.39'(c)
L6	S81°20'17"E	24.59'(c)


Proposed Self-Support Tower
Lat. = 37°25'41.03" North (NAD 1983)
Lon. = 85°39'31.79" West (NAD 1983)
Ground Elev. = 961.4 ft. or 293.04 m (NAVD 1988)

Lease Tract
0.230 Acres or 10,000 Sq. Ft.
No Zoning in Green County
Floyd Evans and Sandra Evans
Deed Book 216, Page 686

P.O.C. of Lease Tract
Southwest corner of the Floyd Evans and Sandra Evans 58.0081-acre tract, as described in Deed Book 216, Page 686.

Legend

- 5/8" Rebar Set Flush With A Survey Cap Inscribed "D.L. Helms PLS 3386"
- 5/8" Rebar Set Flush - No Cap
- ⊙ 3/4" Iron Pipe Found Exposed 30" And Bent
- ⊕ Calculated Position - No Monument Found or Set
- Subject Boundaries
- - - Other Boundaries
- Easement Boundary
- - - Right of Way
- ⊙ Utility Pole
- ☆ Light Pole
- ⊕ Guy Anchor
- ⊕ Telephone Pedestal
- (m) Measured
- (r) Recorded
- (c) Calculated
- (s) Set

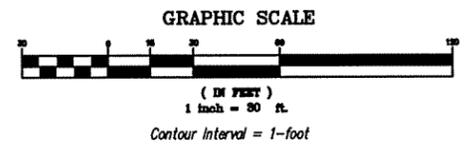

- ### Surveyor's Notes
- This survey is subject to a statement of facts which may be disclosed by an Abstract of Title or a Title Commitment Policy. This documentation was not provided by the client.
 - No search of public records has been performed by this firm to determine any defects and/or ambiguities in the title of the parent tract.
 - The utilities shown on this plat may or may not represent all of the utilities located on the subject site. The presence of the existing utilities shown was determined by a visual inspection of the property surface. No utility locate was called in prior to this survey. It shall be the responsibility of the contractor to locate any utilities present prior to construction.
 - The topographic information contained on this plat was as requested by the client and may or may not represent all of the topographic features located on the subject property.
 - According to Mary Ann Blaydes Baron, County Judge Executive of Green County, no local planning unit exists which has geographical jurisdiction of the subject tower site. The County Judge Executive's Office may be contacted at 270-932-4024 for confirmation.

Lease Boundary and Easement Description

A tract of land that is located adjacent to the east side of Sand Ridge Road and about 0.8 miles southerly of the intersection of said road with Bird Road in the Mt. Sherman Community of Green County, Kentucky; said tract being described as follows:

COMMENCING AT a 3/4-inch iron pipe found exposed 30 inches at the southwest corner of the Floyd Evans and Sandra Evans 58.0081-acre tract, as described in Deed Book 216, page 686 in the office of the County Clerk of Green County, Kentucky; thence North 01 degree 12 minutes 47 seconds West 460.33 feet to a 5/8-inch rebar set flush with a survey cap inscribed "D.L. Helms PLS 3386" (referred to as a rebar in the remainder of this description) at the POINT OF BEGINNING of this description; thence North 08 degrees 39 minutes 43 seconds East 100.00 feet to a rebar set flush; thence South 81 degrees 20 minutes 17 seconds East 100.00 feet to a rebar set flush; thence South 08 degrees 39 minutes 43 seconds West 100.00 feet to a rebar set flush; thence North 81 degrees 20 minutes 17 seconds West 100.00 feet to the point of beginning and containing 0.230 acres (10,000 square feet), more or less.

TOGETHER WITH an access and utility easement from the above-described 0.230-acre lease tract to Sand Ridge Road; said easement being described as follows: BEGINNING AT a 5/8-inch rebar set flush with a survey cap inscribed "D.L. Helms PLS 3386" at the southwest corner of the above-described 0.230-acre lease tract; thence North 81 degrees 20 minutes 17 seconds West 25.00 feet to the eastern boundary of Sand Ridge Road (20 feet from the centerline); thence along said eastern boundary the following four (4) courses: (1) North 13 degrees 32 minutes 10 seconds East 40.00 feet; (2) North 10 degrees 59 minutes 53 seconds East 20.00 feet; (3) North 06 degrees 11 minutes 02 seconds East 20.00 feet and (4) North 00 degrees 22 minutes 38 seconds East 20.39 feet; thence South 81 degrees 20 minutes 17 seconds East 24.59 feet to a 5/8-inch rebar set flush with said Helms survey cap at the northwest corner of the above-described 0.230-acre lease tract; thence South 08 degrees 39 minutes 43 seconds West 100.00 feet to the point of beginning.

The bearing system of these descriptions is based upon the Kentucky State Plane Coordinate System, South Zone, NAD 1983 (2007), as determined by G.P.S. observations made on November 15, 2007 using the National Geodetic Survey monument "R 222". These descriptions are based upon a survey completed by Landmark Surveying Co., Inc. and certified by Darren L. Helms, P.L.S. 3386, on November 26, 2007. This survey is hereby referenced and made a part of these descriptions.

SOURCE OF TITLE: Being a portion of and lying entirely within the land described in deed to Floyd Evans and Sandra Evans on October 9, 2006 in Deed Book 216, page 686 in the office of the County Clerk of Green County, Kentucky.

Surveyor's Certification

I hereby certify that this plat has been compiled from a survey actually made upon the ground under my direct supervision on November 26, 2007 by the method of random traverse with sideshots. The unadjusted precision ratio of the traverse was better than 1:37,400 and it was not adjusted. This survey is a Class B survey and the accuracy and precision of this survey meets all the specifications of this class.

Darren L. Helms, P.L.S. 3386

Date

Landmark Surveying Co., Inc.
15 N.E. 3rd Street
Washington, Indiana 47301
(812) 257-0650
Email: landmark@landmark.net
Project No. 07-11-018




Lease Boundary Survey
788 Sand Ridge Road
Magnolia, Kentucky 42757

Bluegrass Cellular
2902 Ring Road
Elizabethtown, Kentucky 42701

REVISIONS	DATE

DATE: 11-26-07
DRAWN BY: A. Whiler
CHECKED BY: D.L. Helms

SHEET NO. 1
OF 1 SHEETS
FILE NO. green_north.dwg

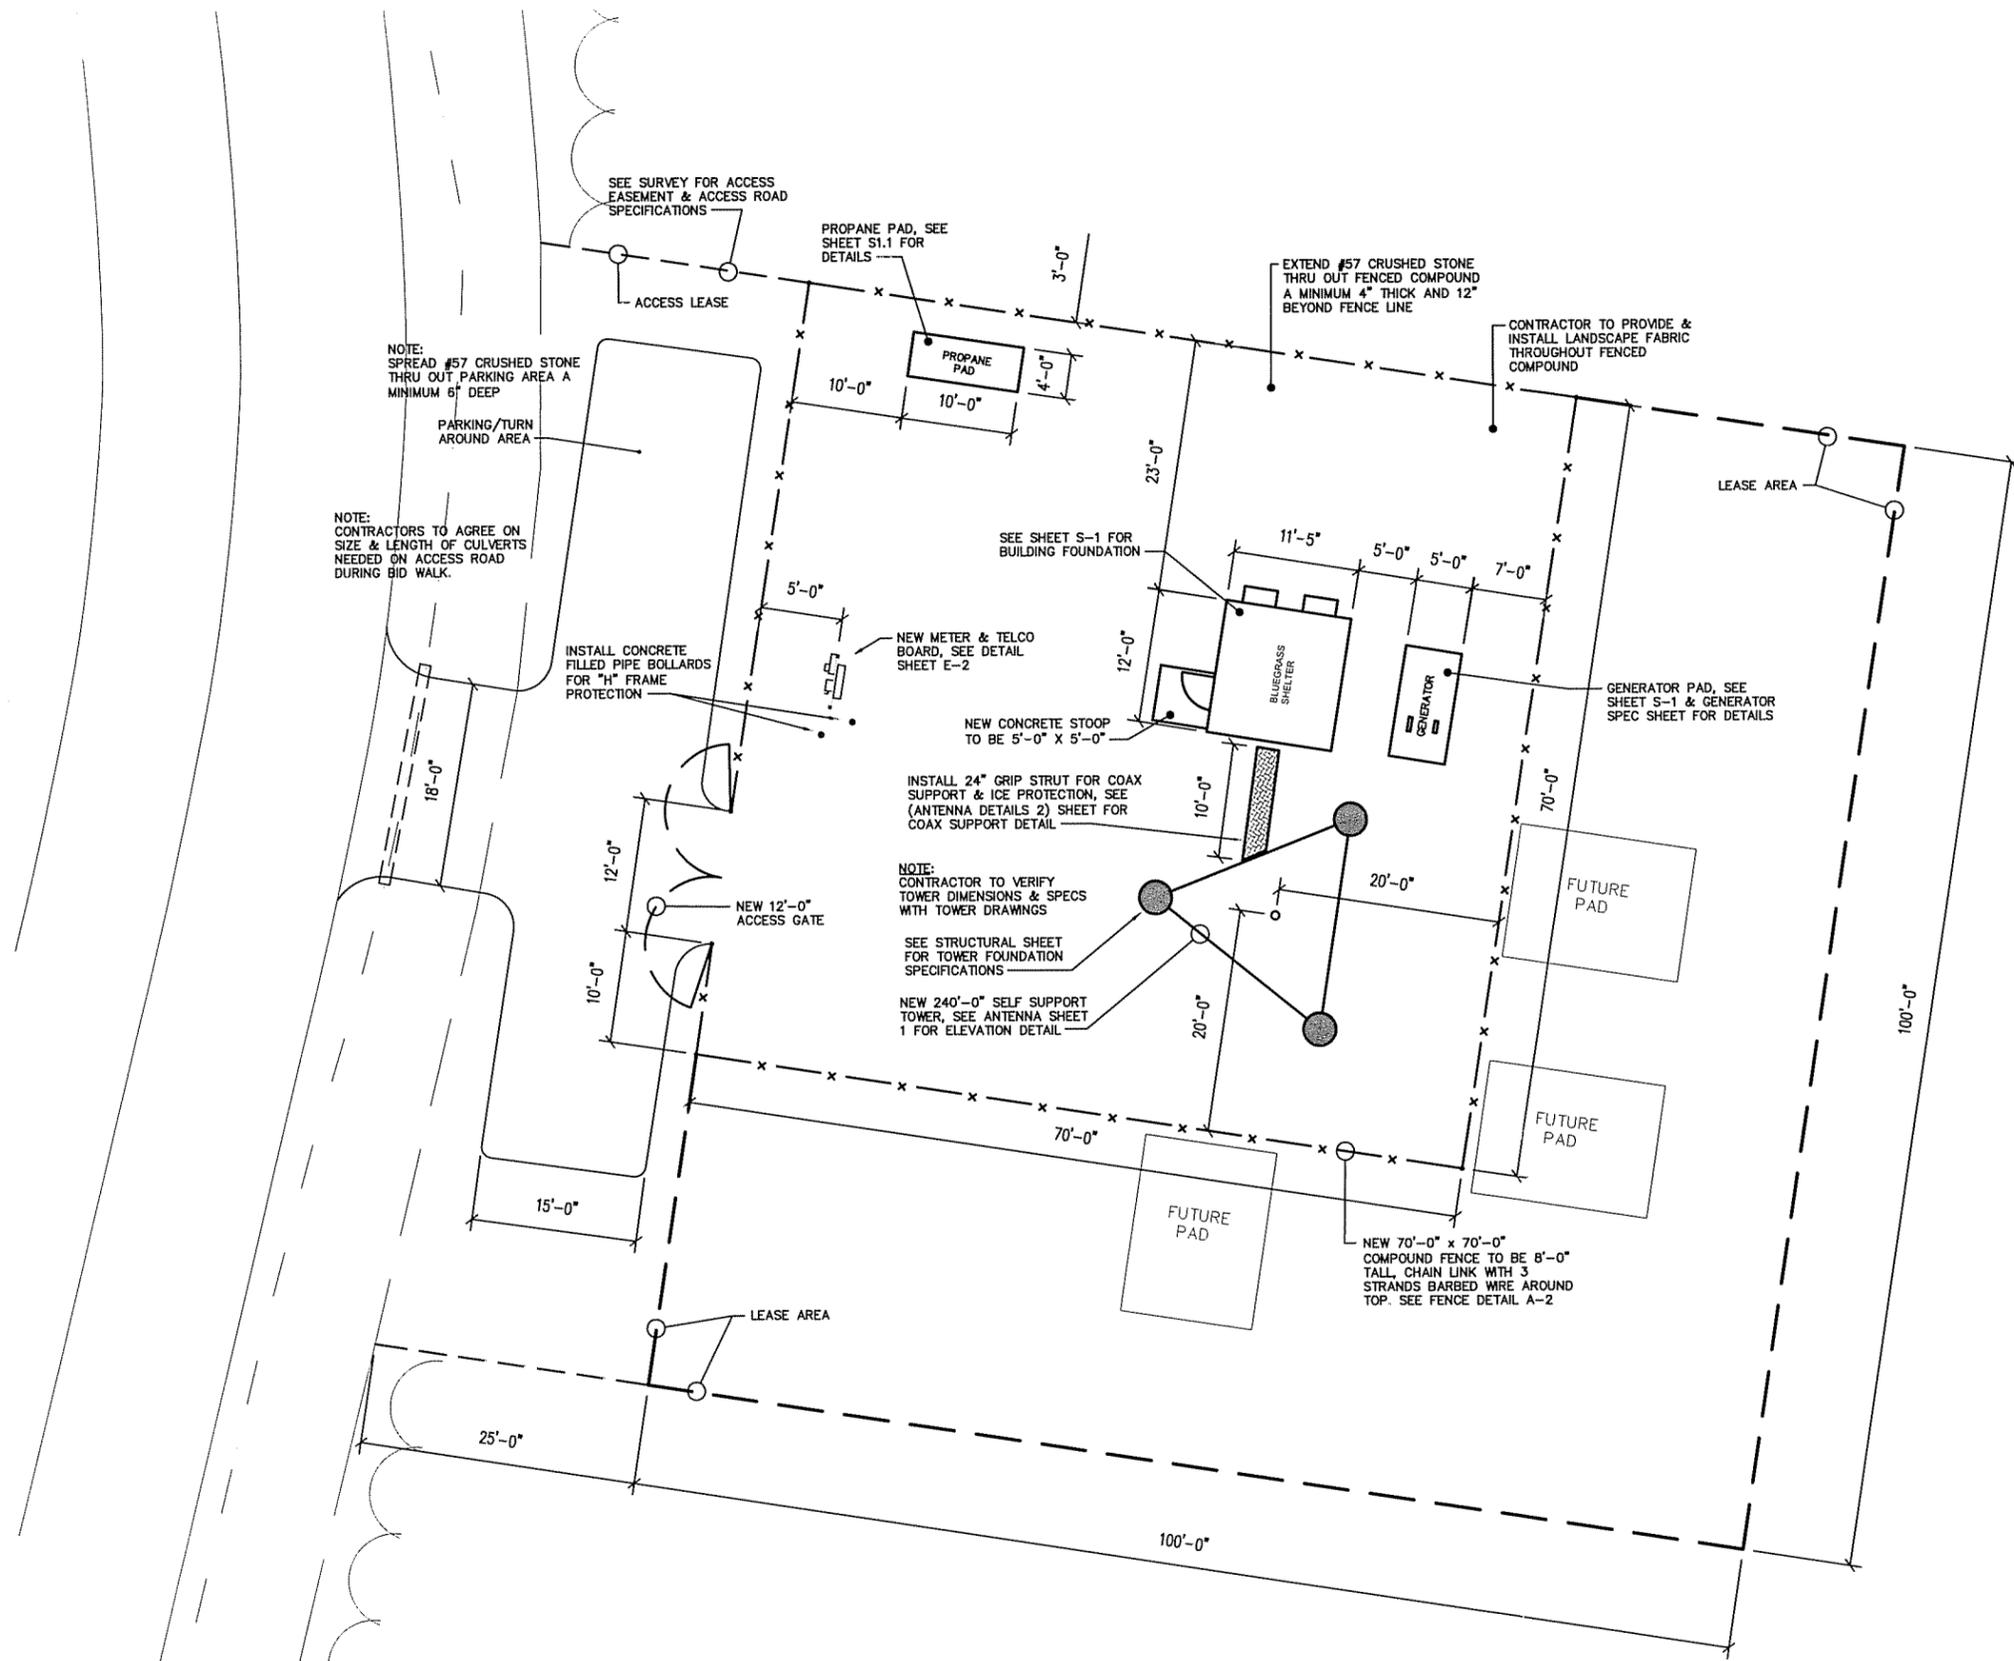

GENERAL NOTES:

- 1) EQUIPMENT PICK-UP AND DELIVERY TO SITE FROM BLUEGRASS CELLULAR STAGING FACILITY TO BE THE CONTRACTORS RESPONSIBILITY, INCLUDING CRANE SET, AND ALL COST INCURRED.
- 2) FOR, BUILDING AND ALL CONCRETE PAD DETAILS REFER TO STRUCTURALS AND SHEET S1.1
- 3) ALL CONCRETE TO HAVE SPECIFIED COATED SEALANT PER STRUCTURAL RECOMMENDATIONS.
- 4) ANY DAMAGE DUE TO CONSTRUCTION, TO BE REPAIRED OR REPLACED TO ORIGINAL CONDITION. (SUBJECT TO BLUEGRASS CELLULAR'S APPROVAL).
- 5) ANY DAMAGE OF NATURAL SURROUNDINGS, INCLUDING BUT NOT LIMITED TO, GRASS, TREES, LANDSCAPING, ETC.. TO BE REPAIRED OR REPLACED TO ORIGINAL CONDITION AT BLUEGRASS CELLULAR'S APPROVAL.
- 6) ROADWAYS TO BE GRADED SMOOTH AND EVEN, REMOVING ALL POTHOLES. ROADS TO HAVE PROPER DRAINAGE AND RUNOFF PER BLUEGRASS CELLULAR'S APPROVAL.
- 7) ANY RELOCATION OF EXISTING UTILITIES TO BE DONE IN ACCORDANCE WITH LOCAL CODES AND RECOMMENDATIONS, CONSULTING ALL UTILITY COMPANIES INVOLVED FOR APPROVAL AND SPECIFICATIONS REQUIRED.
- 8) FOR GRADING DETAILS, SEE GENERAL NOTESHEET
- 9) CONTRACTOR TO FIELD VERIFY ALL TOWER DIMENSIONS WITH TOWER MANUFACTURER PRIOR TO JOB BIDDING OR START OF ANY CONSTRUCTION
- 10) CONTRACTOR RESPONSIBLE FOR APPLYING FOR SERVICE TO SITE AND PAYING ANY FEES REQUIRED FOR PERMITS, HOOKUP, ETC..

SITE PLAN

SCALE: 1/8" = 1'-0"




NO.	DATE	REVISION


BLUEGRASS CELLULAR, INC.
STANDARD CELLULAR SITE
GREEN NORTH
 788 SAND RIDGE RD. MAGNOLIA, KY. 42757

DRAWN BY: R. BECKER	ISSUE DATE: 1-14-08	SCALE: LISTED
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SHEET NUMBER
 A-1

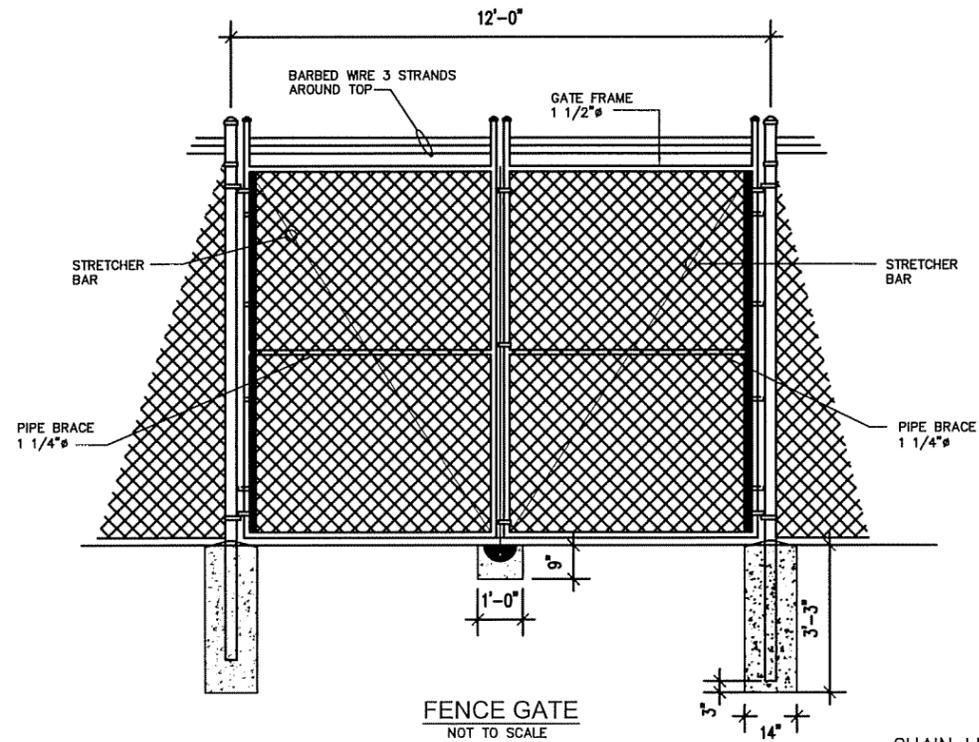


FENCE GATE
NOT TO SCALE

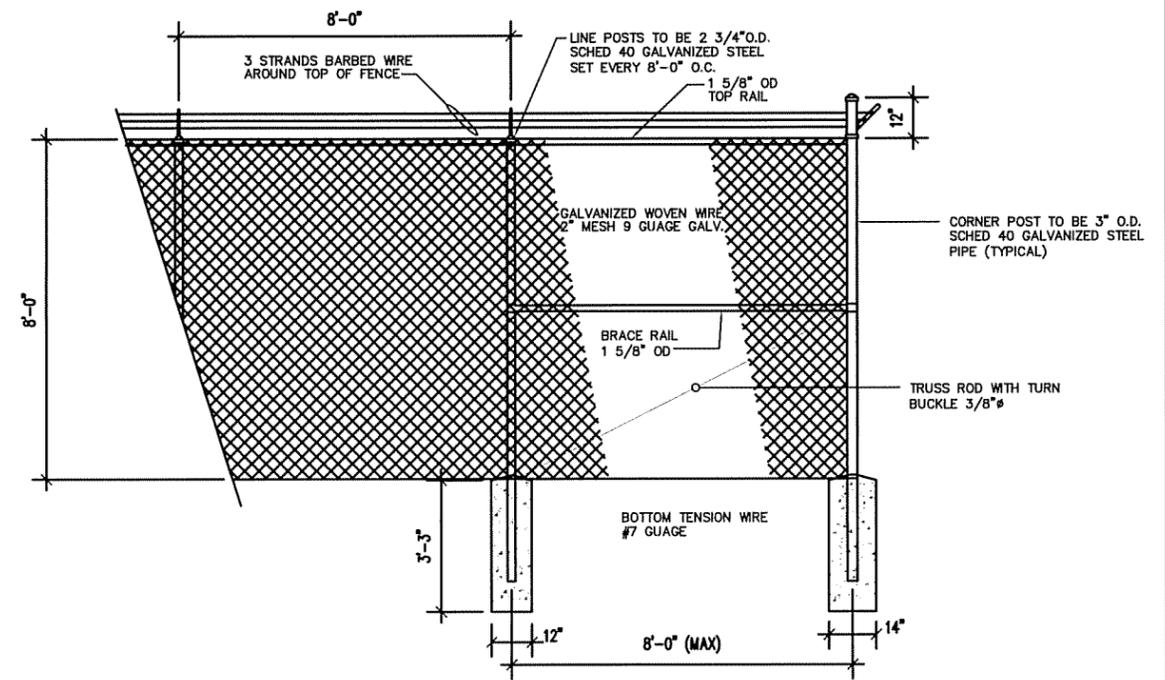


FENCE DETAIL END POLES
NOT TO SCALE

CHAIN LINK FENCING NOTES:


- 1 **FABRIC:** THE FABRIC SHALL BE COMPOSED OF INDIVIDUAL HOT DIP GALVANIZED WIRE PICKETS HELICALLY WOUND AND INTERWOVEN FROM NO.9 W & M GAUGE COPPER BEARING STEEL WIRE TO FORM A CONTINUOUS CHAIN LINK FABRIC HAVING A 2" MESH. TOP EDGES SHALL HAVE A TWISTED AND BARBED
- 2 **POSTS:** SHALL BE 2 3/4" O.D. SS 40 PIPE HOT GALVANIZED. THESE POSTS SHALL BE SPACED APPROXIMATELY 8'-0" ON CENTERS AND SET FULL 3'-3" IN BELL - SHAPED CONCRETE FOOTING, CROWNED AT TOP TO SHED WATER.
- 3 **TOP RAIL:** SHALL BE 1 5/8" O.C. STANDARD PIPE HOT GALVANIZED AND SHALL BE FURNISHED IN RANDOM LENGTHS AVERAGING NOT LESS THAN 20".
- 4 **FABRIC TIES:** FOR ATTACHING FABRIC TO LINE POST, TOP RAIL OR TOP WIRE, SHALL BE ALUMINUM STRIP OF WIRE OF APPROVED GAUGE AND DESIGN. USED ON TOP OF RAIL EVERY 24" AND ONE POST EVERY 12".
- 5 **EXTENSION ARMS:** CAST STEEL GALVANIZED TO ACCOMODATE 3 STRANDS OF BARB WIRE, SINGLE ARM SLOPED TO 45°, AND VERTICAL ON TOP OF SWING GATES.
- 6 **BARBED WIRE (STEEL):** ASTM A121 GALVANIZED STEEL, 12 GAUGE THICK WIRE, 3 STRANDS 4 POINTS AT 3" O.C.
- 7 **SWING GATE POSTS:** SHALL BE 3" O.C. STANDARD HOT GALVANIZED, WEIGHING 5.79 LBS. PER FOOT.
- 8 **GATES: (a) SWING GATES:** 2" O.C. STANDARD PIPE WITH INTERNAL BRACING OF 1 5/8" O.D. STANDARD PIPE; WELDED AT ALL JOINTS TO PROVIDE RIGID WATERTIGHT CONSTRUCTION. FABRIC SAME AS FENCE.
- 9 FENCE TO BE 100% ERECTED WITHIN TEN(10) DAYS OF COMPLETION OF CONSTRUCTION, IF TIME FRAME CANNOT BE MET, PLEASE NOTIFY PROJECT SUPERVISOR.

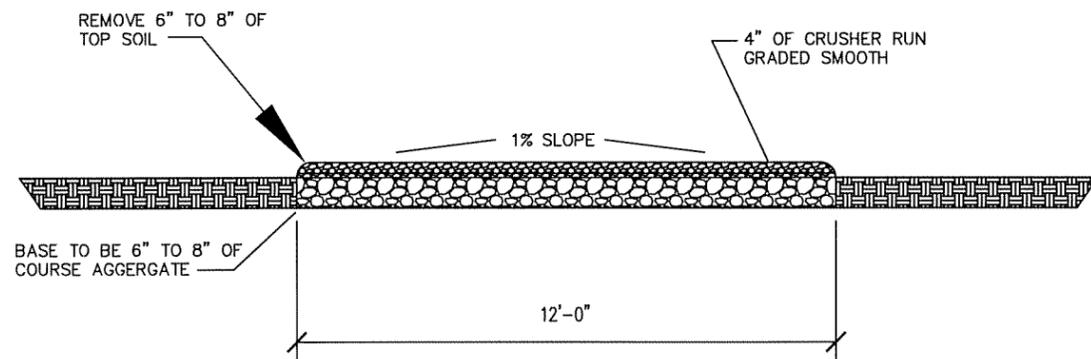

ROAD DETAIL
NOT TO SCALE

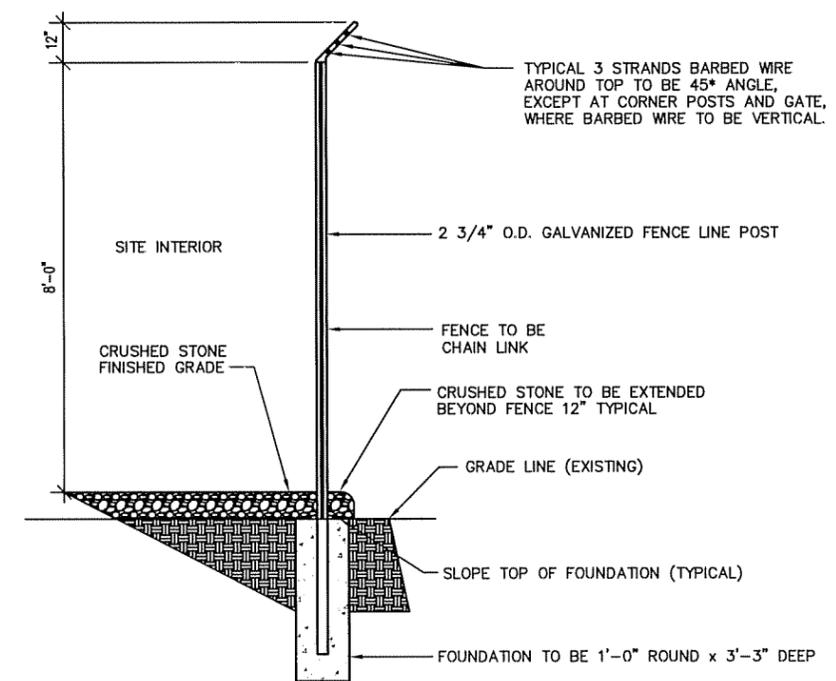

FENCE DETAIL LINE POLES
NOT TO SCALE

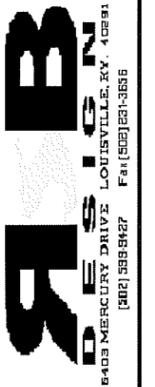

BLUEGRASS CELLULAR, INC.
840 MERCURY DRIVE
LOUISVILLE, KY. 40291
FAX (502) 261-3656

NO.	DATE	REVISION

BLUEGRASS CELLULAR, INC.
STANDARD CELLULAR SITE
GREEN NORTH
788 SAND RIDGE RD. MAGNOLIA, KY. 42757

DRAWN BY: R. BECKER
ISSUE DATE: 1-14-08
SCALE: LISTED

SHEET NUMBER
A-2

BLUEGRASS CELLULAR GENERAL NOTES & ANTENNA SPECS

ALL LINES AND ANTENNAS TO BE PROPERLY MOUNTED TO TOWER OR STRUCTURE PER BLUEGRASS CELLULAR SPECIFICATIONS.

ALL GROUND BARS TO BE INSTALLED AND CAD WELDED TO GROUND FIELD (WHERE REQUIRED)

ALL LINES TO BE GROUNDED AT THE TOP AND BASE OF STRUCTURE OR TOWER.

ALL LINES TO BE GROUNDED AT ENTRANCE OF SHELTER BEFORE WAVE GUIDE PORTS. (EXTERIOR OF BUILDING)

LINES ARE TO BE SECURED TO ICE BRIDGE

WAVE-GUIDE BOOTS ARE TO BE INSTALLED ON ALL LINES (BOTH INSIDE AND OUTSIDE)

ALL COAX CONNECTIONS ARE TO BE WEATHER PROOFED. INVENTORY OF ALL MATERIAL IS TO BE DONE PRIOR TO INSTALLATION BY CONTRACTOR. (LIST WILL BE PROVIDED)

ALL TRASH AND REFUGE IS TO BE PROPERLY DISPOSED OF.

CONTRACTOR TO EXTEND HARDLINES INTO BUILDING 12" & INSTALL POLYPHASERS, PER INSTRUCTION OF PROJECT SUPERVISOR.



CONTRACTORS TO SUPPLY POLYPHASERS OR LIKE UNITS TO BE INSTALLED AND GROUNDED TO GROUND BAR INSIDE BUILDING AT WAVE GUIDE ENTRANCE. GO TO SUPPLY GROUND CABLE & LUGS.

GENERAL CONTRACTOR TO MOUNT ANTENNA MOUNTS AT TOP OF STRUCTURE OR TOWER BY BLUEGRASS CELLULAR SPECIFICATIONS.

ICE BRIDGE TO BE SUPPLIED AND INSTALLED BY GENERAL CONTRACTOR. (Additional Ice Bridge if needed)

TRAPEZE KIT TO BE SUPPLIED AND INSTALLED BY GENERAL CONTRACTOR.

CONTRACTOR TO INSTALL GPS BRACKET

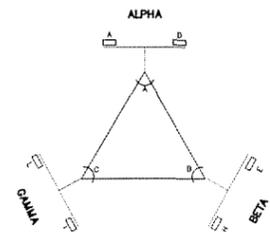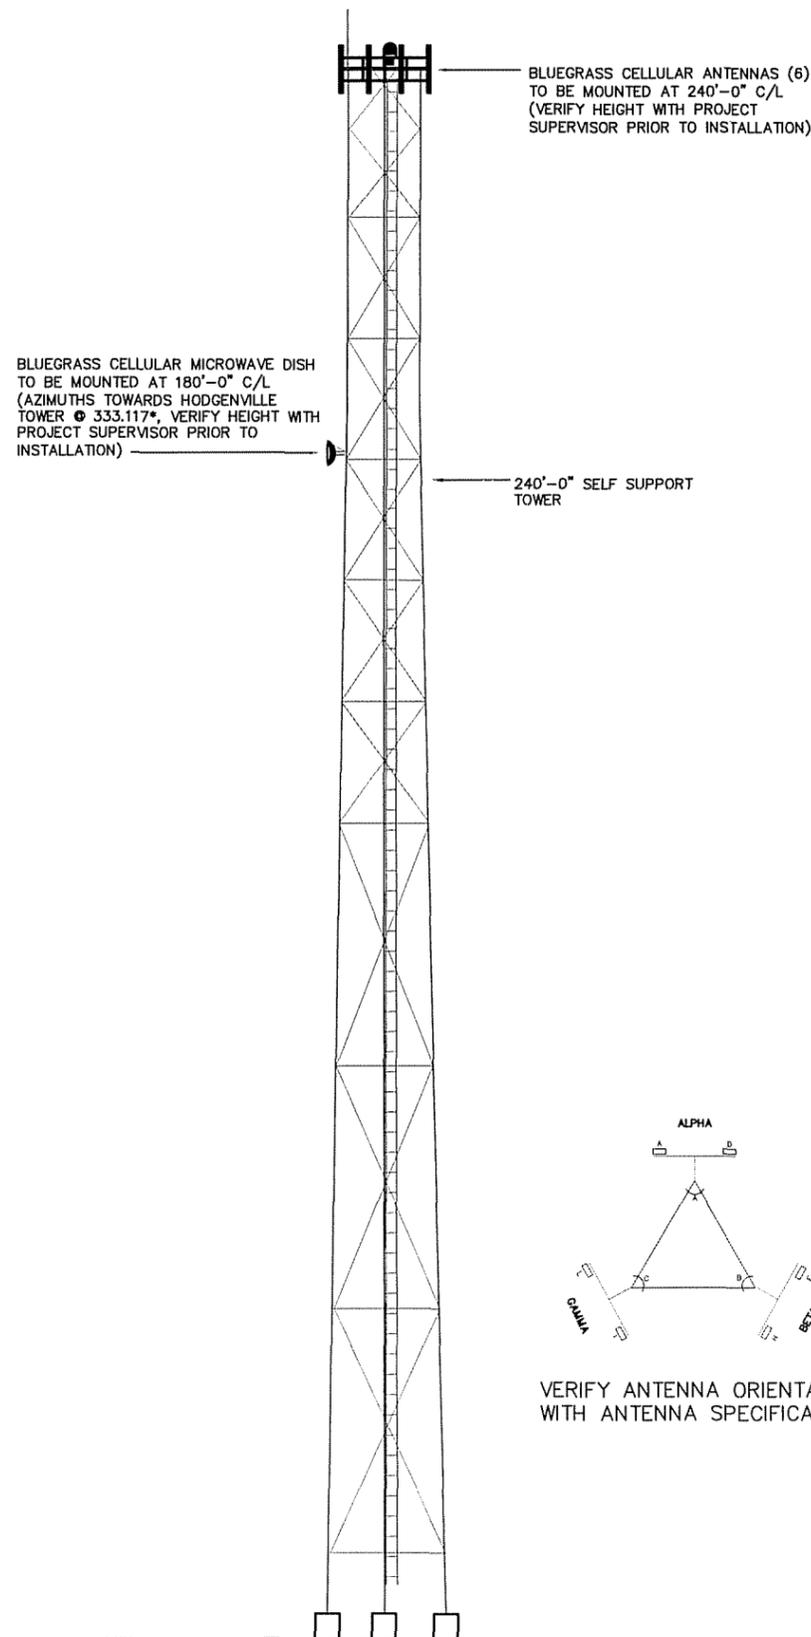

VERIFY ANTENNA ORIENTATION WITH ANTENNA SPECIFICATIONS

SELF SUPPORT TOWER ELEVATION (TYPICAL)

TOWER HEIGHT & TYPE

240'-0" SELF SUPPORT TOWER

ANTENNA SPECS

	TYPE	SIZE L x W x D	NUMBER	AZIMUTH	MOUNTING HEIGHT
ANTENNA (PRIMARY)	AP13-880-8500 ADT-XP	L=78.6 W=10.3 D=4.6	6	0*, 120*, 240*	240'-0" C/L <small>VERIFY WITH CONSTRUCTION SUPERVISOR</small>
ANTENNA (SECONDARY)					

ANTENNA MOUNTING HARDWARE SPECS

	TYPE	SIZE	NUMBER
MOUNT (PRIMARY)	TRI-SECTOR MOUNT		3
MOUNT (SECONDARY)			

ANTENNA TRANSMISSION LINES SPECS

	TYPE	SIZE	NUMBER
TRANSMISSION LINE (PRIMARY)	ANDREW	1-5/8"	6
TRANSMISSION LINE (SECONDARY)			

DISH SPECS

	MICROWAVE/DONOR	SIZE	NUMBER	AZIMUTH	MOUNTING HEIGHT
DISH #1	TPG-QF4-52-N	4'	1	333.117*	180'-0" C/L FIELD VERIFY
DISH #2				153.074*	170'-0" C/L FIELD VERIFY

DISH MOUNT SPECS

	TYPE	SIZE	NUMBER
MOUNT #1			
MOUNT #2			

DISH TRANSMISSION LINES

	TYPE	SIZE	NUMBER
TRANSMISSION LINE #1	LDF4.5-50A		1
TRANSMISSION LINE #2			

ANTENNA SYNOPSIS

- * ANTENNAS TO HAVE A 1*E X,Y,Z
- * ANTENNA FREQUENCY 880.00 - 890.00
- * MICROWAVE DISH MOUNTED AT 180'-0" C/L WITH AZIMUTHS @ 333.117*




BLUEGRASS CELLULAR, INC.
STANDARD CELLULAR SITE
GREEN NORTH
788 SAND RIDGE RD. MAGNOLIA, KY. 42757

NO.	DATE	REVISION


BLUEGRASS CELLULAR, INC.
STANDARD CELLULAR SITE
GREEN NORTH
788 SAND RIDGE RD. MAGNOLIA, KY. 42757

DRAWN BY: R. BECKER
ISSUE DATE: 1-14-08
SCALE: LISTED


SHEET NUMBER
ANTENNA DETAILS
1

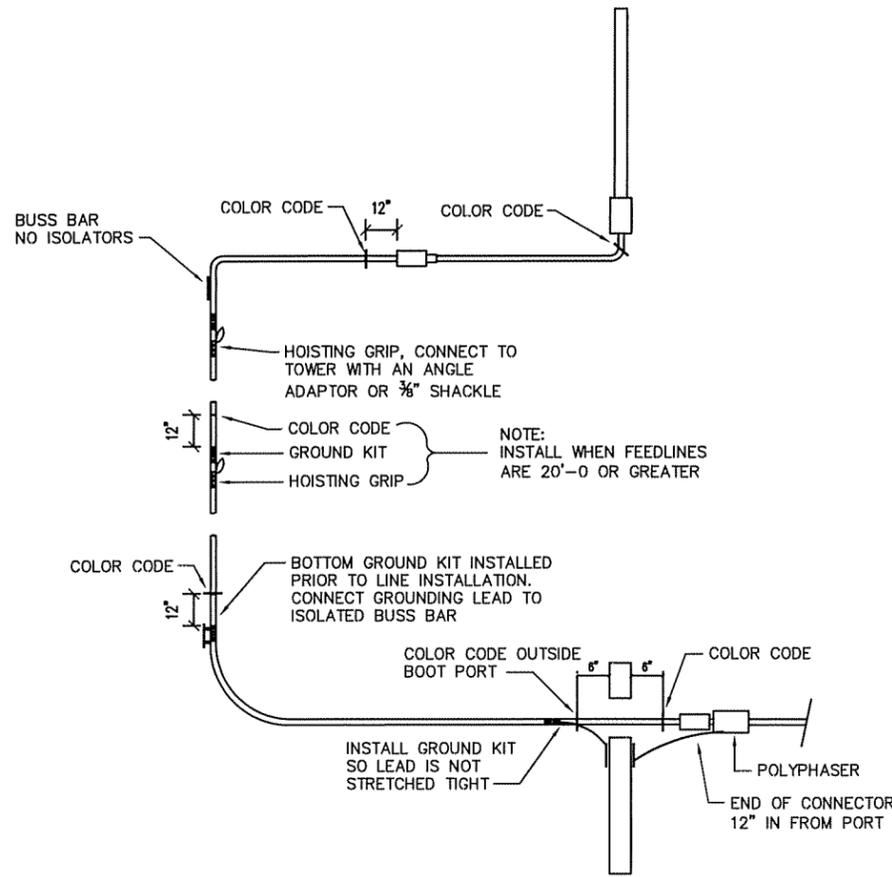


COLOR CODING DETAIL
NO SCALE

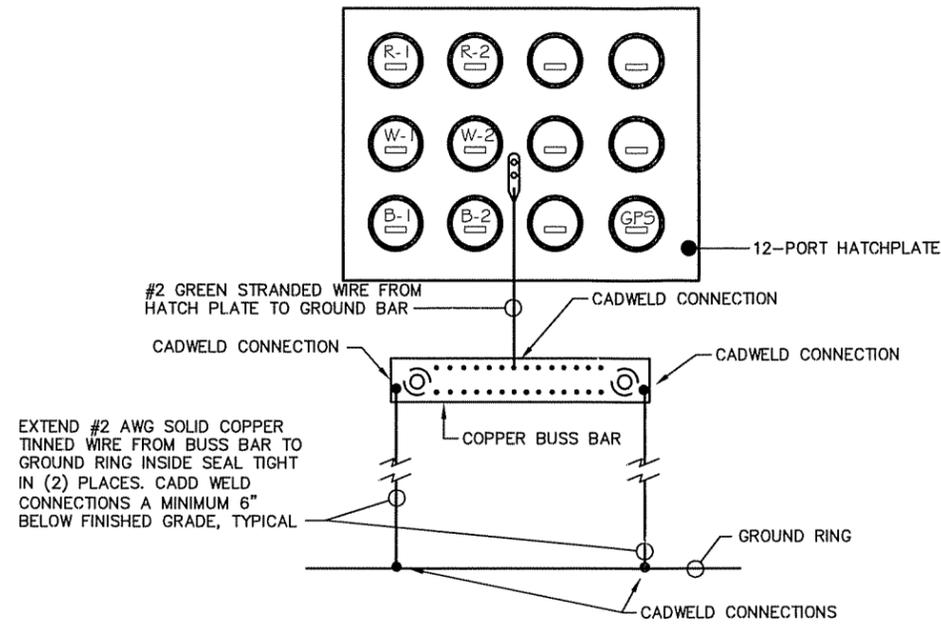


BOOT PORT GROUNDING DETAIL
NO SCALE

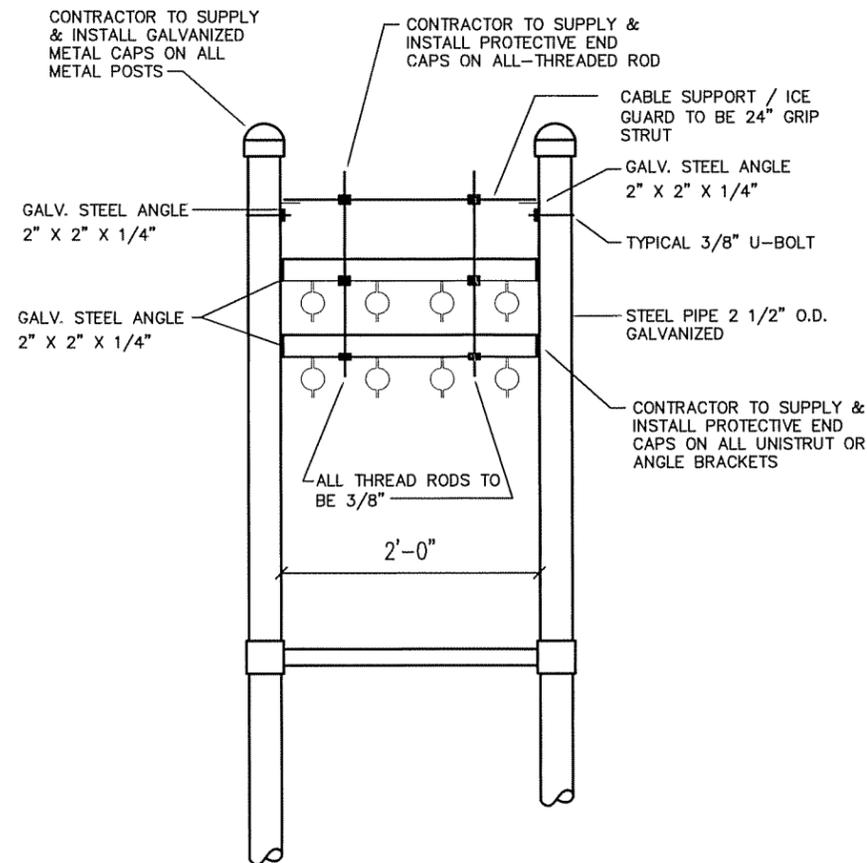

ICE BRIDGE / COAX SUPPORT DETAIL
NO SCALE

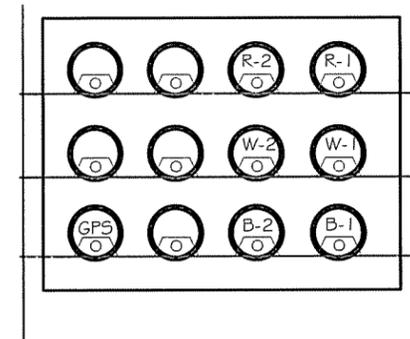

**COAX ENTRY DETAIL POWER SIDE
(VIEW FROM INSIDE SHELTER)**
NO SCALE

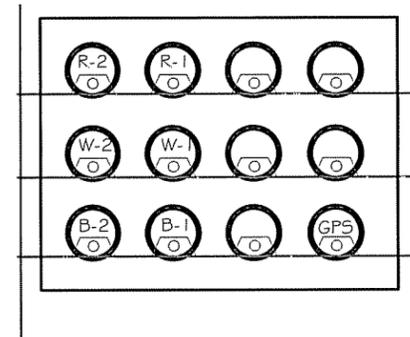

**COAX ENTRY DETAIL A/C SIDE
(VIEW FROM INSIDE SHELTER)**
NO SCALE




NO.	DATE	REVISION

BLUEGRASS CELLULAR, INC.
STANDARD CELLULAR SITE
GREEN NORTH
788 SAND RIDGE RD. MAGNOLIA, KY. 42757

DRAWN BY: R. BECKER
ISSUE DATE: 1-14-08
SCALE: LISTED

SHEET NUMBER
ANTENNA DETAILS
2

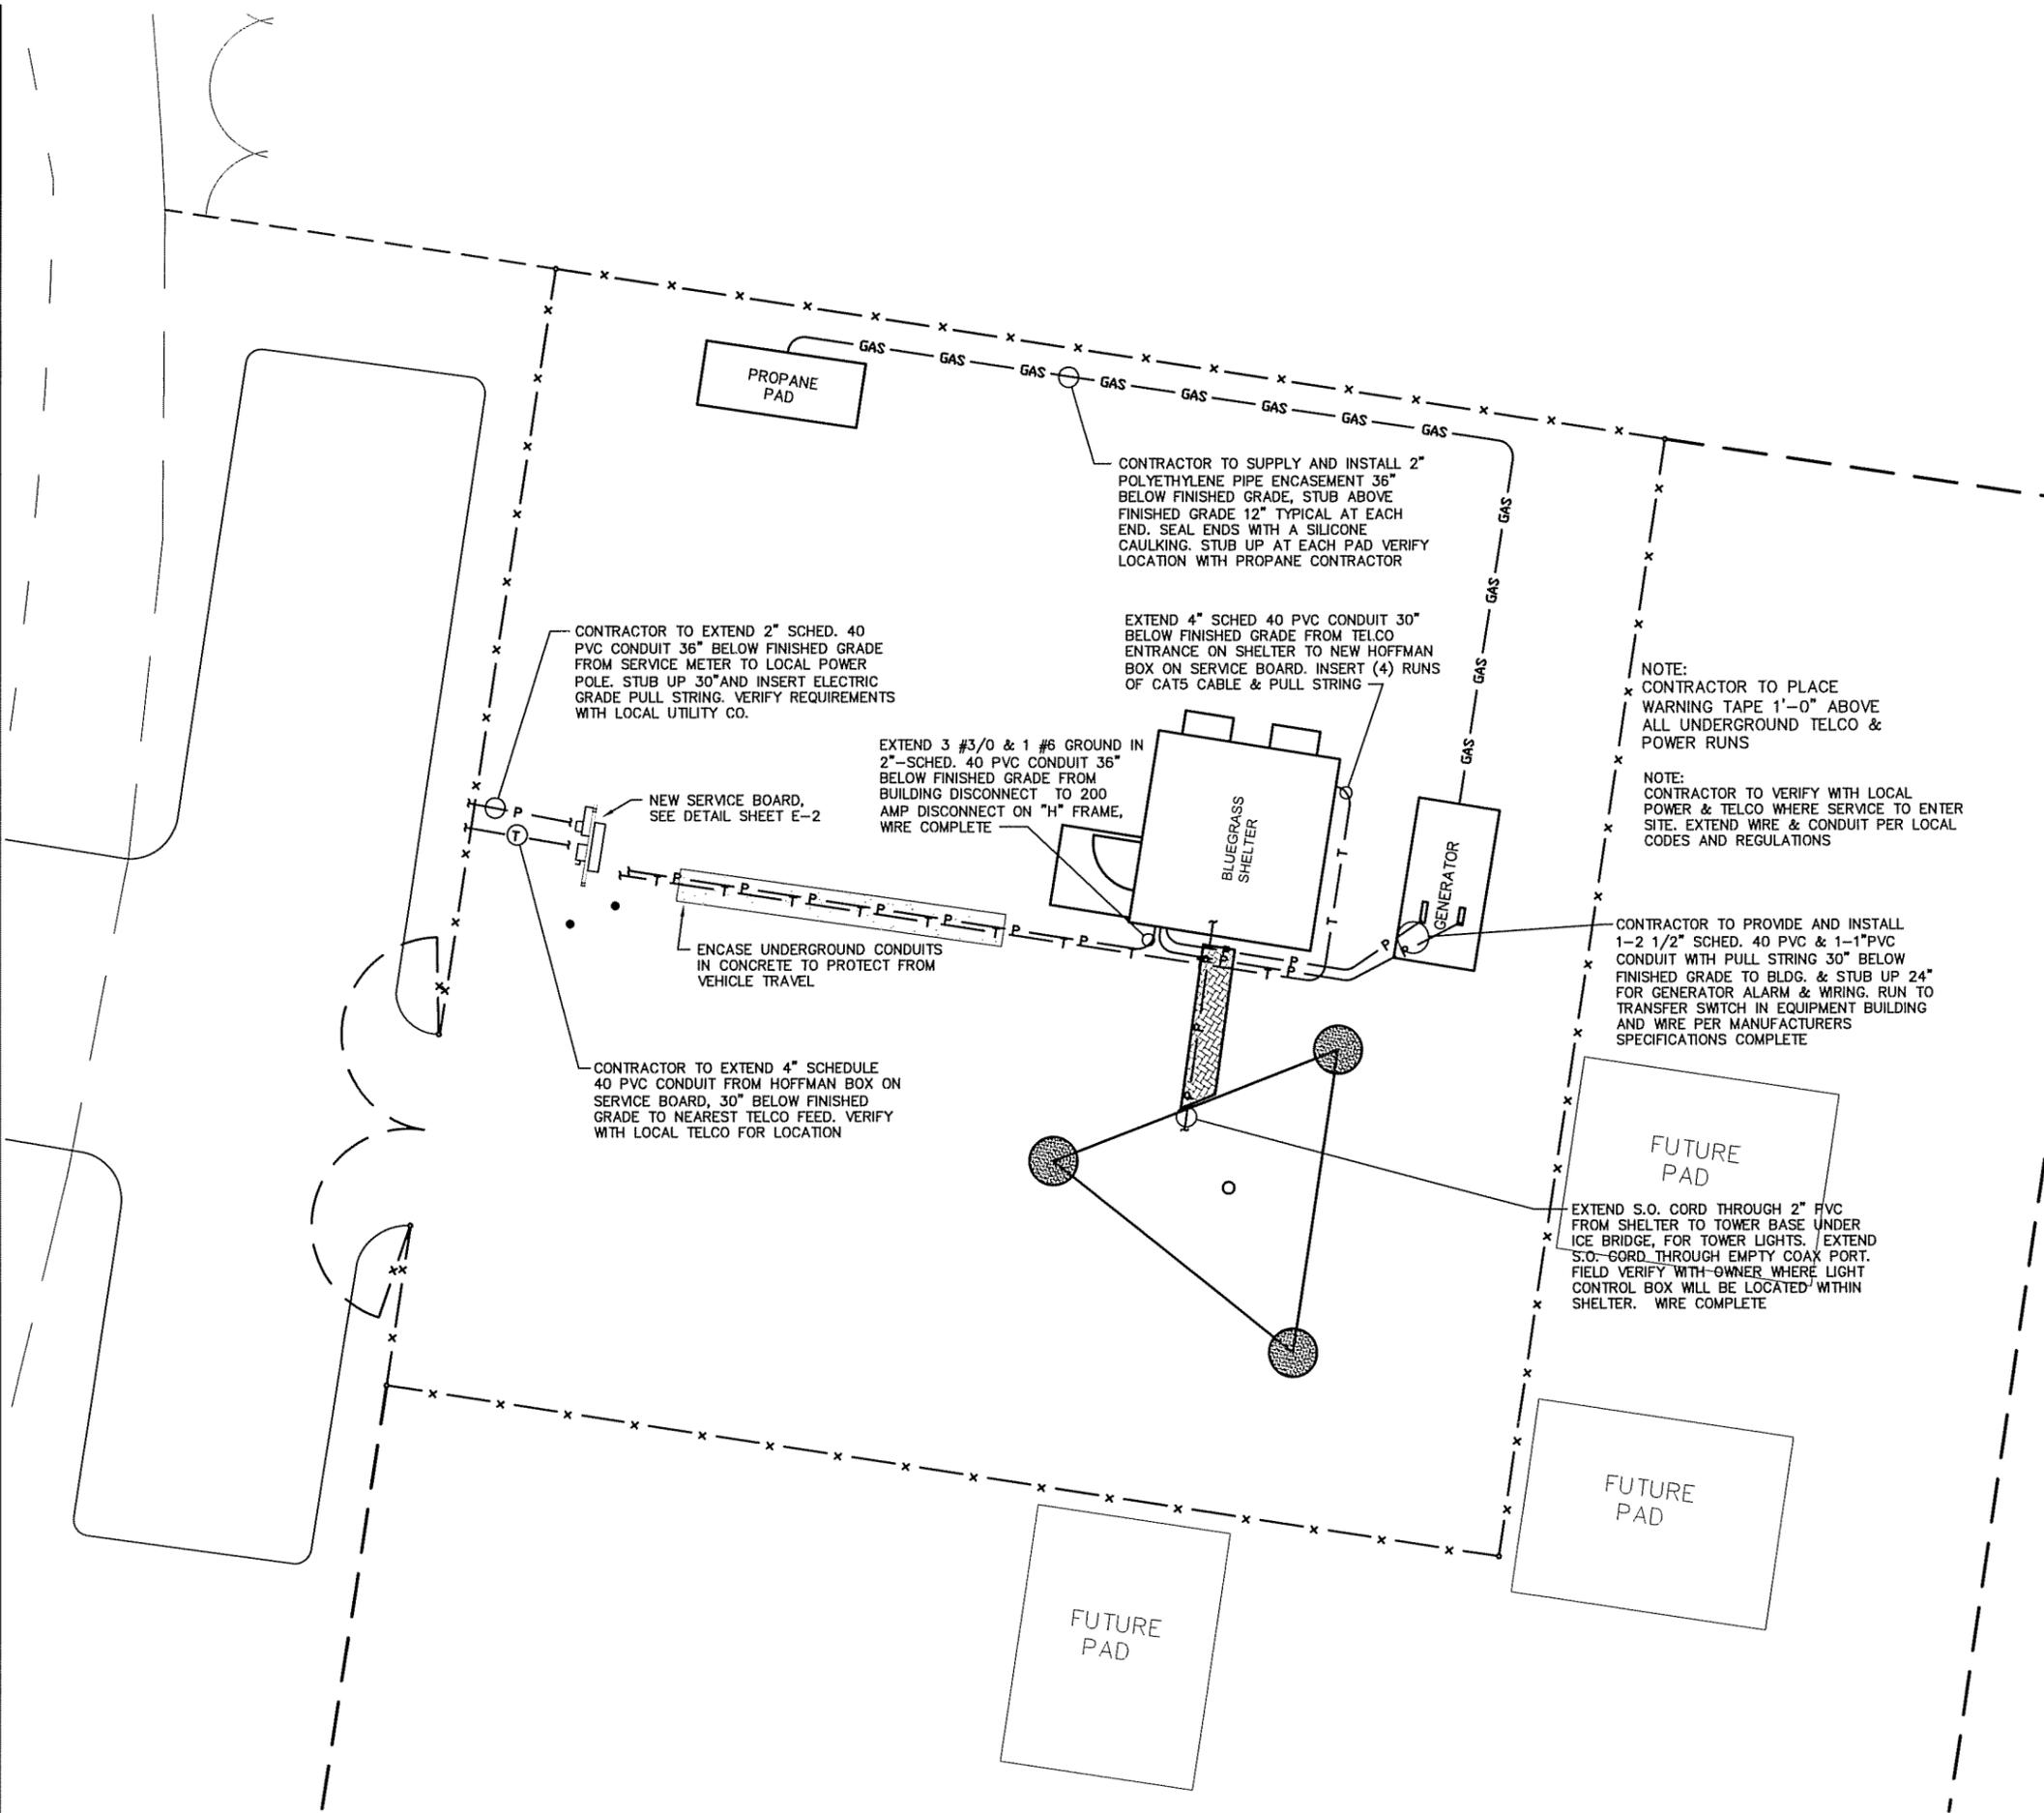

- GENERAL ELECTRICAL NOTES:**
- 1) CONTRACTOR RESPONSIBLE FOR MAKING ALL ARRANGEMENTS WITH THE LOCAL UTILITIES FOR SERVICE AND FEE PAYMENTS REQUIRED TO OBTAIN SERVICE.
 - 2) CONTRACTOR RESPONSIBLE FOR MAKING ALL ARRANGEMENTS WITH THE LOCAL TELEPHONE COMPANY FOR SERVICE AND FEE PAYMENTS REQUIRED TO OBTAIN SERVICE.
 - 3) GROUND RING TO BE CONTAINED WITH IN THE COMPOUNDS FENCED AREA.
 - 4) FENCE TO BE GROUNDED FROM GROUND RING TO ALL CORNER POST & GATES. SPACE FENCE GROUNDING APPROXIMATELY 20'-0" O/C. (CAD WELD ALL CONNECTIONS)

5) ALL GROUND RING CONNECTIONS TO BE AS CLOSE AS POSSIBLE, SHARP BENDS WILL NOT BE PERMITTED AS WELL AS "T" CONNECTIONS. ALL CONNECTIONS TO HAVE A SWEEPING RADIUS OF 8" MINIMUM. GROUNDING CONFIGURATION TO BE IN PARALLEL.

6) CONTACT POINTS FOR GROUNDING TO BE CLEANED OF ANY RUST, PAINT, DIRT, ETC. TO CREATE A GOOD BOND FOR CONDUCTOR. AREA THAT HAS BEEN CLEANED TO BE RESEALED TO PREVENT RUSTING.

7) PROPERLY GROUND ANY EXPOSED METAL THAT MAY EXIST ON EXTERIOR OF EQUIPMENT SHELTER OR CABINET.

8) WHERE GROUND CONDUCTORS REQUIRE MECHANICAL BONDING, STAINLESS STEEL CONNECTORS ARE REQUIRED AT EACH CONNECTING POINT USING LOCK WASHERS.

9) CONTRACTOR RESPONSIBLE FOR SEEING THAT UTILITY PERSONNEL MAKE FINAL CONNECTIONS, MAKING SURE THE TOWER ALARM IS CONNECTED AND WORKING. A TELEPHONE NUMBER FOR THE ALARM MUST BE SUPPLIED.

10) CONTRACTOR RESPONSIBLE FOR MEG TESTING THE SITE AND SUPPLYING OWNER WITH FINAL READINGS IN OWNERS SPECIFICATIONS.

NOTE:
CONTRACTOR TO PROVIDE WARNING TAPE IN TRENCHES FOR ALL POWER AND TELCO RUNS UNDER GROUND. TAPE TO BE INSTALLED 1'-0" ABOVE CONDUIT RUNS.

SYMBOLS LEGEND

—P—	POWER
—G—	GAS
—T—	TELEPHONE
—X—	FENCE
⊞	SWITCH (DISCONNECT)
⊞	METER PACK

SITE PLAN- ELECTRICAL


SCALE: 3/32" = 1'-0"




NO.	DATE	REVISION

BLUEGRASS CELLULAR, INC.
STANDARD CELLULAR SITE
GREEN NORTH
788 SAND RIDGE RD. MAGNOLIA, KY. 42757

DRAWN BY: R. BECKER	ISSUE DATE: 1-14-08	SCALE: LISTED
SHEET NUMBER E-1		

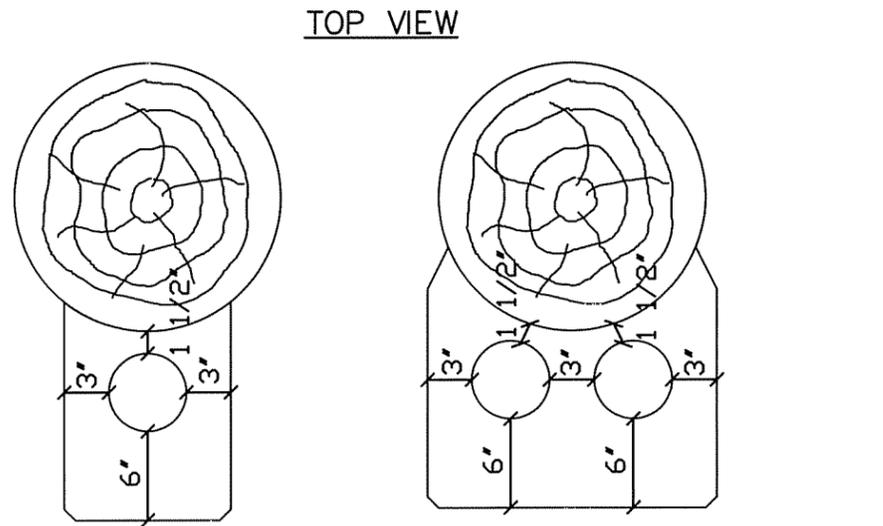


TOP VIEW

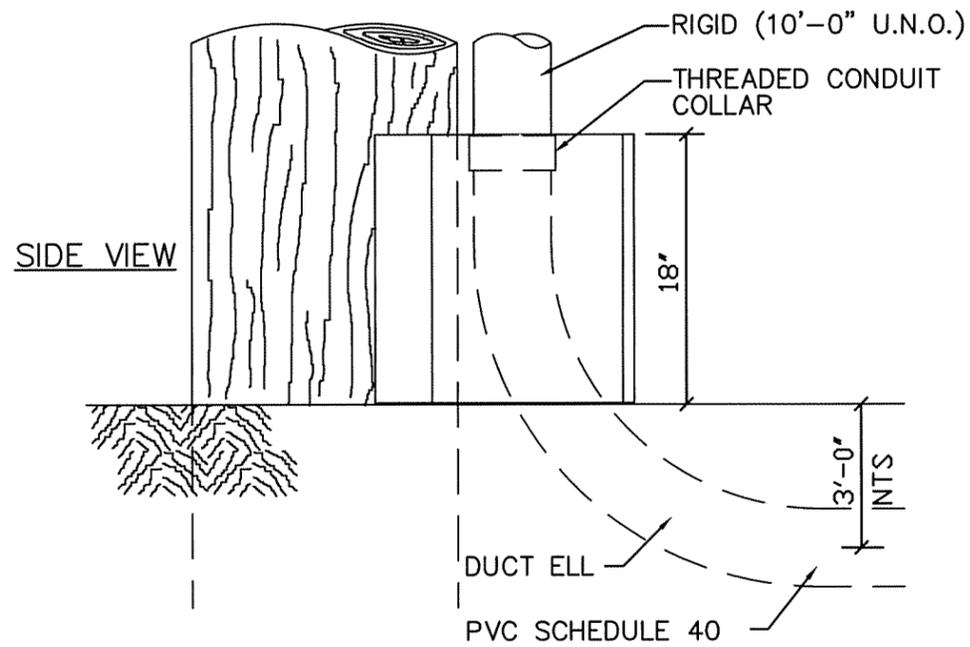

SIDE VIEW


HUB-BAND DETAIL

NO SCALE

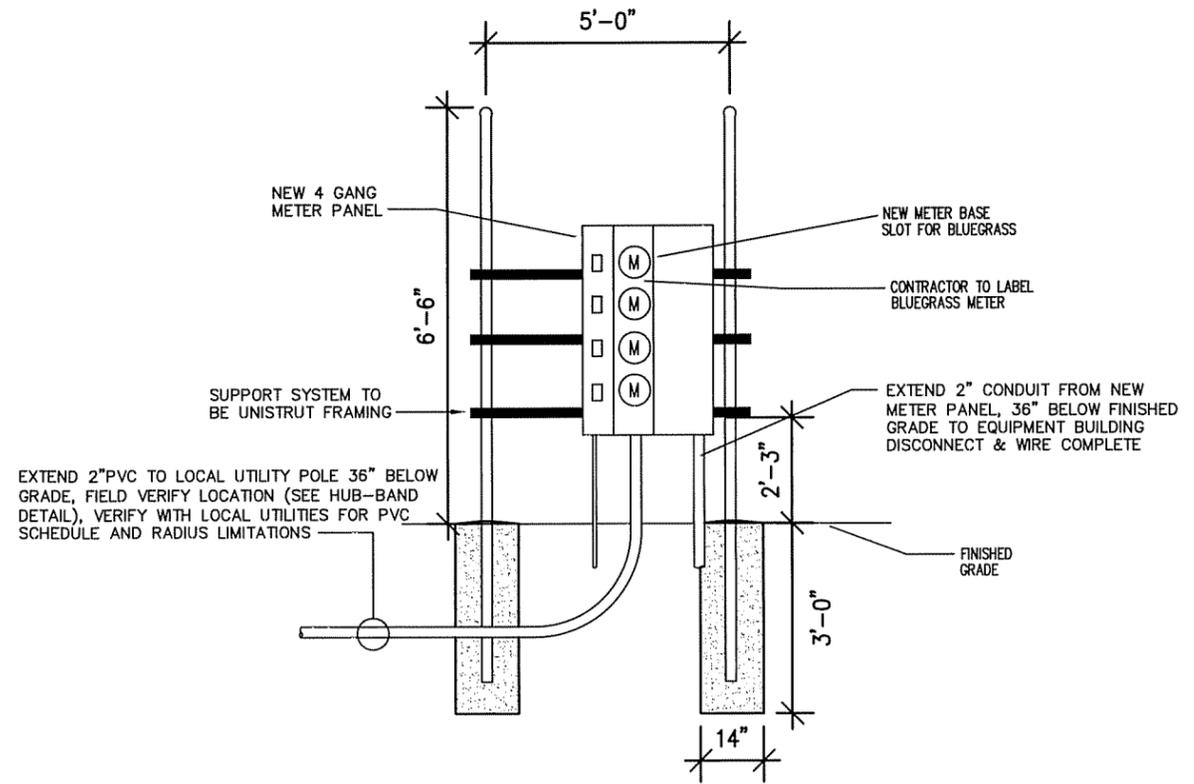

SERVICE BOARD DETAIL

NO SCALE

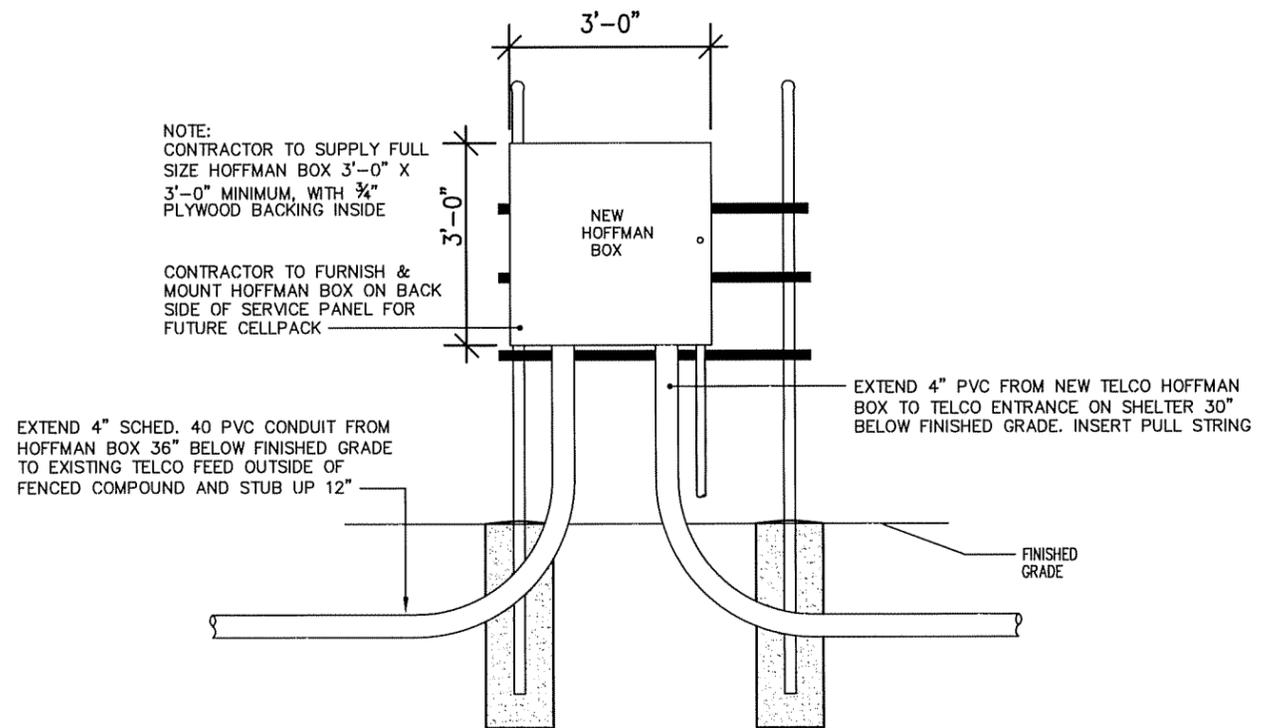

BACKBOARD DETAIL

NO SCALE




BLUEGRASS CELLULAR, INC.
8403 MERCURY DRIVE
LOUISVILLE, KY. 40291
Tel: (502) 251-3656
Fax: (502) 251-3627

NO.	DATE	REVISION

BLUEGRASS CELLULAR, INC.
STANDARD CELLULAR SITE
GREEN NORTH
788 SAND RIDGE RD. MAGNOLIA, KY. 42757


DRAWN BY: R. BECKER
ISSUE DATE: 1-14-08
SCALE: LISTED

SHEET NUMBER
E-2

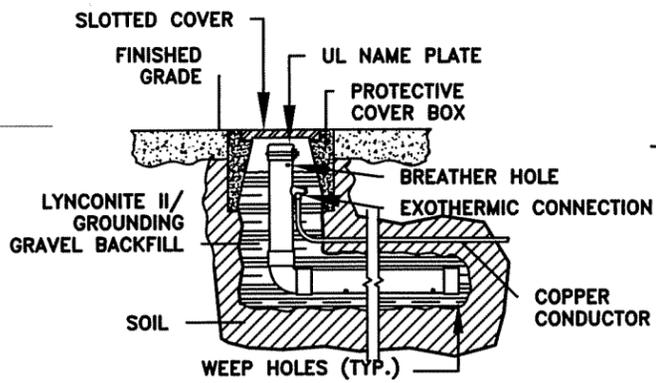

L-SHAPE MODEL
LYNCOLE XIT GROUNDING
(800) 962-2610


DETAIL

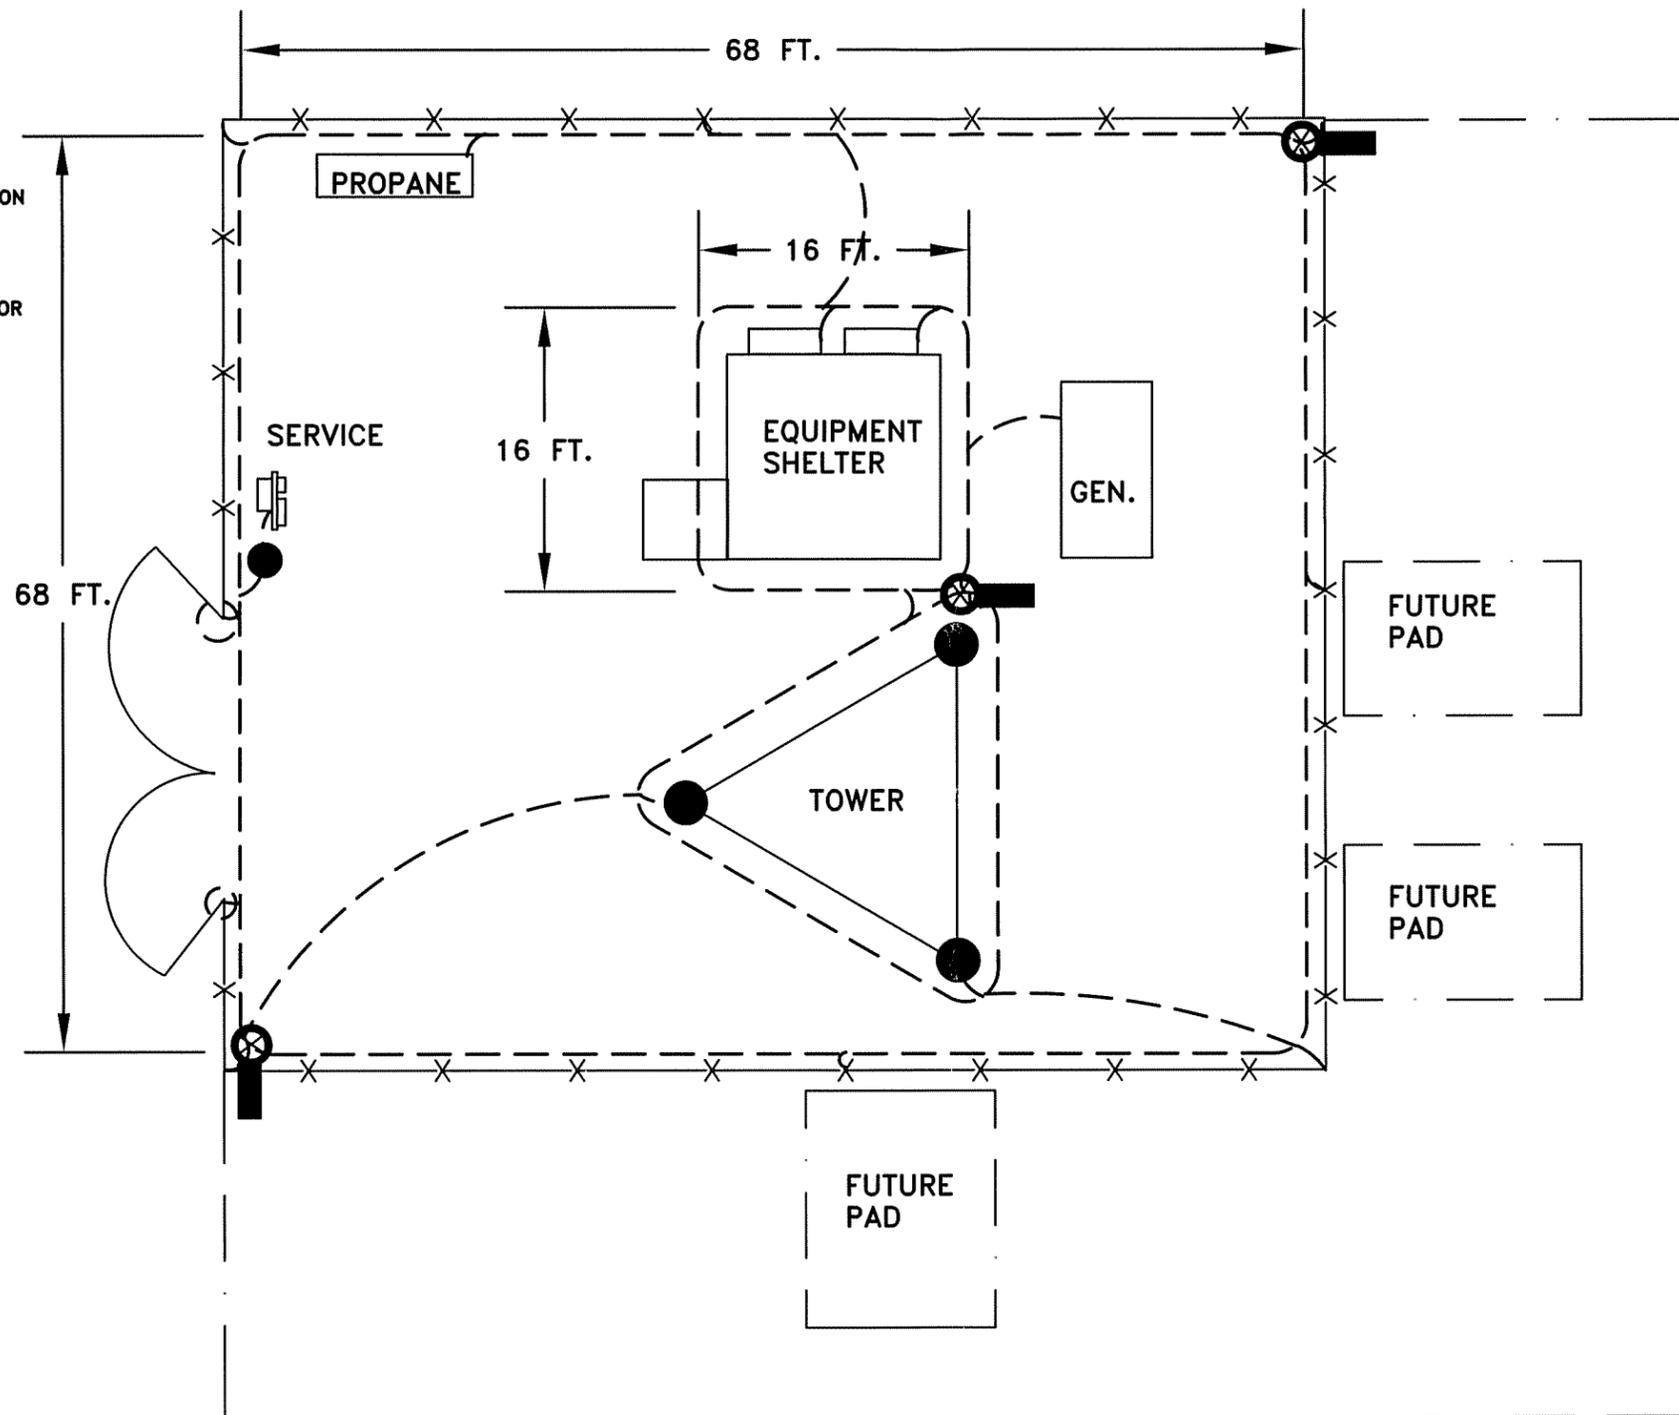

NOTES:

- — — — — LEASE LINE
- X — CHAIN LINK FENCE
- - - - - BARE #2 AWG TINNED SOLID COPPER CONDUCTOR
BURIED 30 IN. BELOW GRADE OR 6 IN. BELOW FROST LINE
ALL BENDS IN GROUND CONDUCTORS TO BE MADE
WITH 12 IN. RADIUS OR LARGER
- ⊗ K2L-10CS (SEE DETAIL)
- 5/8 IN. X 10 FT. COPPER CLAD DRIVEN ROD AT THE SERVICE ENTRANCE

		CLIENT / END USER	
		RSB DESIGN / BLUEGRASS	
DRAWING PROJECT NAME		1 BLUEGRASS GREEN NORTH	
TECHNICAL SERVICES		TITLE	
3547 VOYAGER STREET, SUITE 204 TORRANCE, CA. 90503 (800)962-2610 FAX (310)214-1114 ENGINEERING@LYNCOLE.COM		GROUNDING OPTION	
SOIL DATA PROVIDED BY		LOCATION: CITY, STATE	CALCULATED RESISTANCE
TERRACON		MAGNOLIA, KY	< 46 OHMS
DRAWN BY	APPROVED BY	DATE	
BBD		1/15/08	
REFERENCE NUMBER	SCALE	LTS NUMBER	
N/A	NONE	080019	

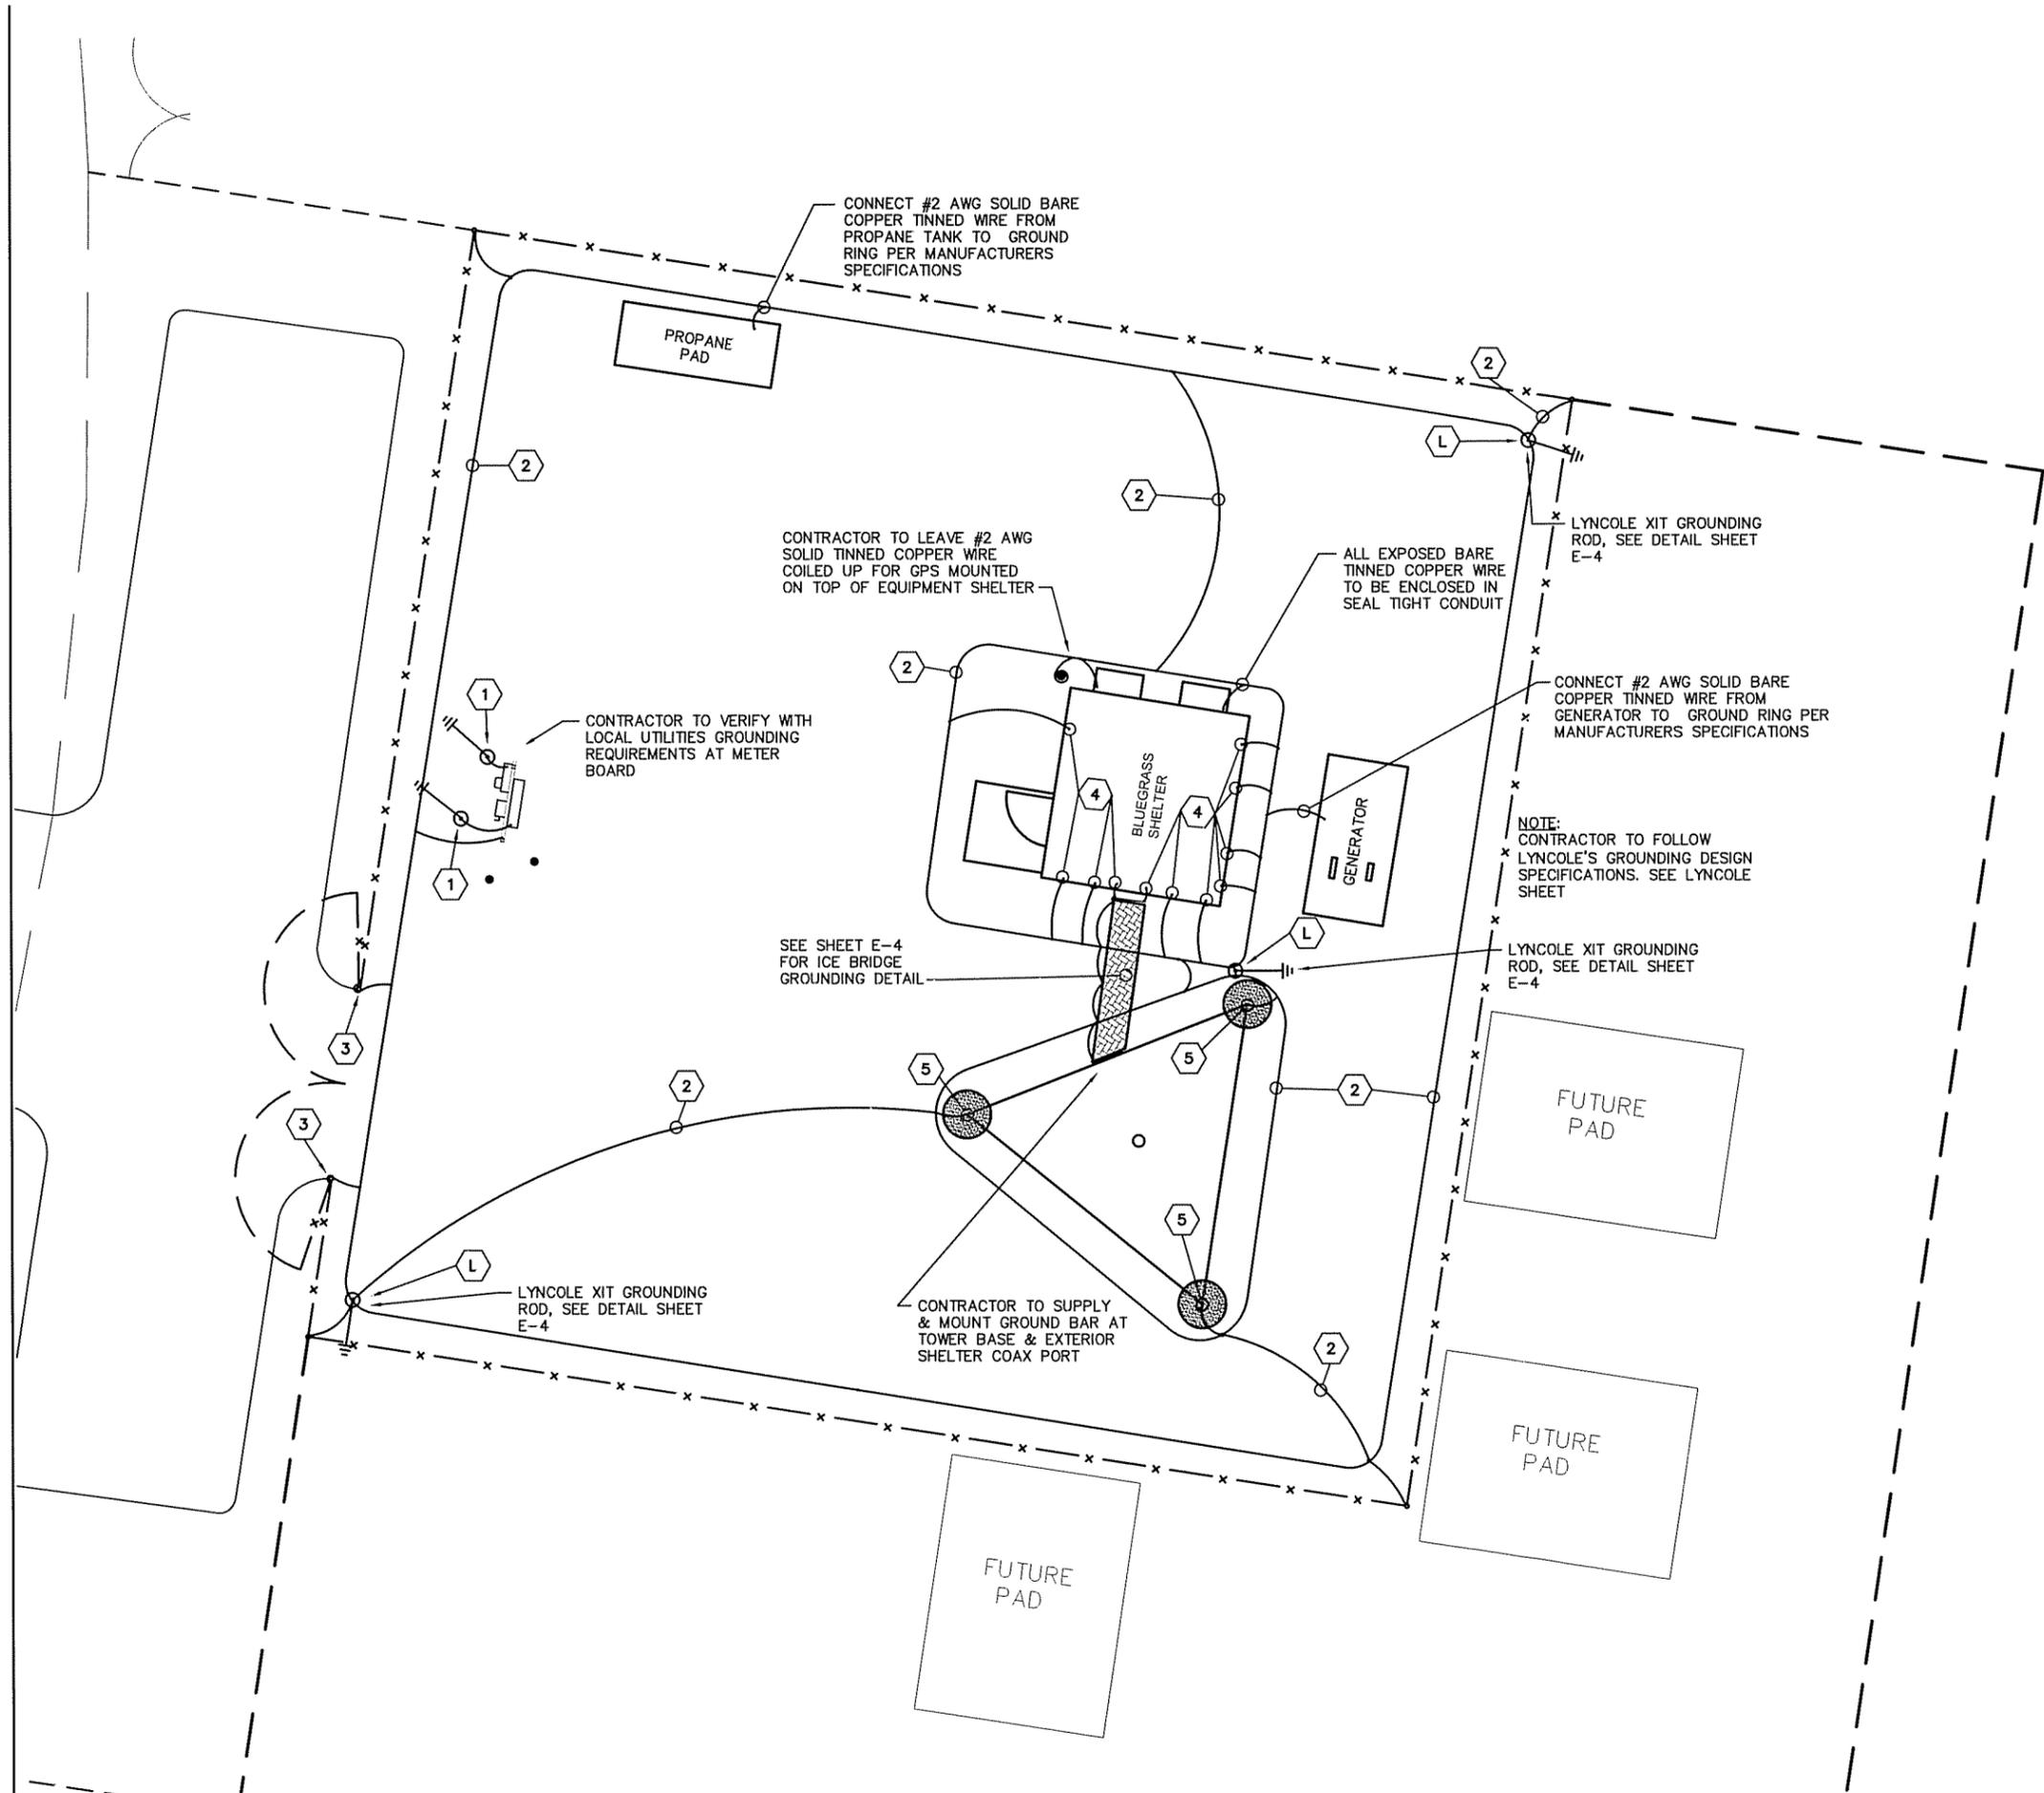

GENERAL ELECTRICAL NOTES:

- 1) CONTRACTOR RESPONSIBLE FOR MAKING ALL ARRANGEMENTS WITH THE LOCAL UTILITIES FOR SERVICE AND FEE PAYMENTS REQUIRED TO OBTAIN SERVICE.
- 2) CONTRACTOR RESPONSIBLE FOR MAKING ALL ARRANGEMENTS WITH THE LOCAL TELEPHONE COMPANY FOR SERVICE AND FEE PAYMENTS REQUIRED TO OBTAIN SERVICE.
- 3) GROUND RING TO BE CONTAINED WITH IN THE COMPOUNDS FENCED AREA.
- 4) FENCE TO BE GROUNDED FROM GROUND RING TO ALL CORNER POST & GATES. SPACE FENCE GROUNDING APPROXIMATELY 20'-0" O/C. (CAD WELD ALL CONNECTIONS)
- 5) ALL GROUND RING CONNECTIONS TO BE AS CLOSE AS POSSIBLE, SHARP BENDS WILL NOT BE PERMITTED AS WELL AS "T" CONNECTIONS. ALL CONNECTIONS TO HAVE A SWEEPING RADIUS OF 8" MINIMUM. GROUNDING CONFIGURATION TO BE IN PARALLEL.
- 6) CONTACT POINTS FOR GROUNDING TO BE CLEANED OF ANY RUST, PAINT, DIRT, ETC. TO CREATE A GOOD BOND FOR CONDUCTOR. AREA THAT HAS BEEN CLEANED TO BE RESEALED TO PREVENT RUSTING.
- 7) PROPERLY GROUND ANY EXPOSED METAL THAT MAY EXIST ON EXTERIOR OF EQUIPMENT SHELTER OR CABINET.
- 8) WHERE GROUND CONDUCTORS REQUIRE MECHANICAL BONDING, STAINLESS STEEL CONNECTORS ARE REQUIRED AT EACH CONNECTING POINT USING LOCK WASHERS.
- 9) CONTRACTOR RESPONSIBLE FOR SEEING THAT UTILITY PERSONNEL MAKE FINAL CONNECTIONS, MAKING SURE THE TOWER ALARM IS CONNECTED AND WORKING. A TELEPHONE NUMBER FOR THE ALARM MUST BE SUPPLIED.
- 10) CONTRACTOR RESPONSIBLE FOR MEG TESTING THE SITE AND SUPPLYING OWNER WITH FINAL READINGS IN OWNERS SPECIFICATIONS.


- NOTE:**
CONTRACTOR TO PROVIDE WARNING TAPE IN TRENCHES FOR ALL POWER AND TELCO RUNS UNDER GROUND. TAPE TO BE INSTALLED AT 9" BELOW GRADE.
- NOTE:**
CONTRACTOR TO FOLLOW LYNCOLES GROUNDING SPECIFICATIONS WHEN USING THEIR XIT GROUNDING RODS. SEE DETAIL SHEET E-4.

KEYNOTES:

- (L) LYNCOLE XIT GROUNDING ROD TO BE INSTALLED WHERE SHOWN AND TO MANUFACTURERS SPECIFICATIONS. (SEE LYNCOLE SPECIFICATIONS)
- (1) GROUNDING RODS 10'-0" LONG x 3/4" COPPER BONDED GROUND RODS
- (2) INSTALL AND PROVIDE SOLID BARE TINNED COPPER WIRE #2 AWG, GROUND RING BELOW GRADE 30". USE #2 AWG SOLID BARE TINNED COPPER GROUND "TAP" CONNECTING CONDUCTORS. (CONNECTIONS FOR ALL TAP CONDUCTORS TO BE PARALLEL AND "CAD WELD" CONNECTIONS)
- (3) FLEXIBLE GROUNDING STRAP TO BE USED TO PROVIDE A COMMON BOND BETWEEN GATE AND CHAIN LINK FENCE, #2 AWG SOLID COPPER BARE TINNED CONDUCTOR FROM GROUND RING TO FENCE USING CAD WELD CONNECTIONS. GROUND TAP TO BE PROVIDED ON EACH 4 SIDES TO GROUND RING AS DESCRIBED ABOVE.
- (4) BONDED GROUND TO BE PROVIDED TO GROUND RING FOR EACH OF THE FOLLOWING: BUILDING STEEL, HATCH PLATE, EMERGENCY RECEPTACLE, WAVE GUIDE STRUCTURE, FRAME WORK, BUILDING DISCONNECT.
- (5) FOR TOWER FRAME GROUNDING, REMOVE GALVANIZED COATING COMPLETELY AT SPOT TO "CAD WELD" TO AND CLEAN. #2 AWG SOLID BARE TINNED COPPER CONDUCTOR TO BE CAD WELDED APPROXIMATELY 1'-0" ABOVE FOUNDATION OR AT FLANGE IF PROVIDED BY TOWER MANUFACTURER. EXTEND CONDUCTOR TO GROUND RING. RIGHT ANGLES NOT ACCEPTED ALL BENDS TO BE SWEEPING.

SITE PLAN-GROUNDING


SCALE: 3/32" = 1'-0"

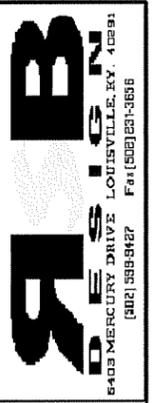

NO.	DATE	REVISION


BLUEGRASS CELLULAR, INC.
STANDARD CELLULAR SITE
GREEN NORTH
 788 SAND RIDGE RD. MAGNOLIA, KY. 42757

DRAWN BY: R. BECKER	ISSUE DATE: 1-14-08	SCALE: LISTED
SHEET NUMBER E-3		

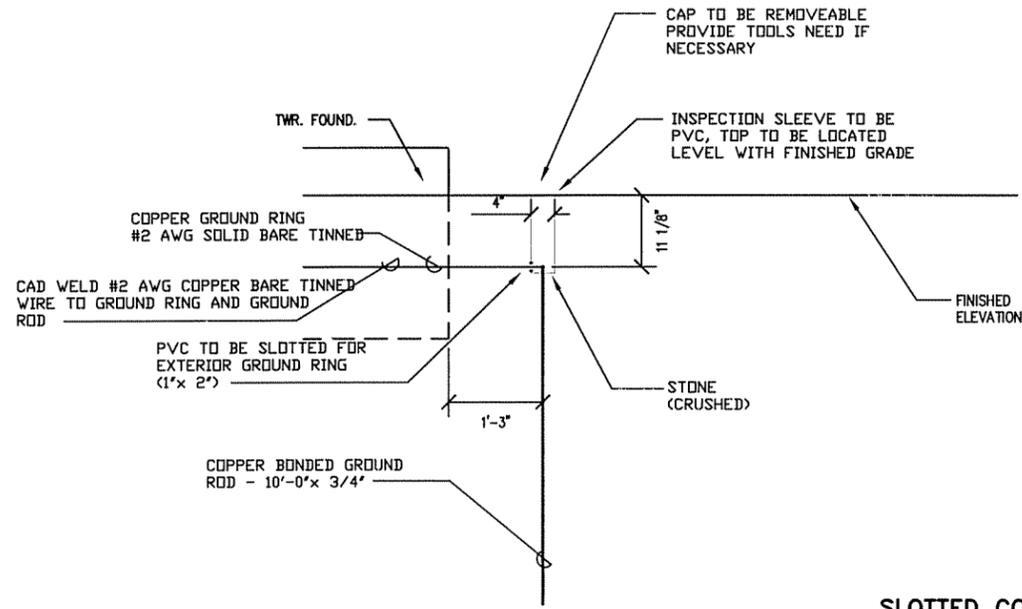

GROUND ROD DETAIL


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L-SHAPE MODEL
LYNCOLE XIT GROUNDING
(800) 962-2610

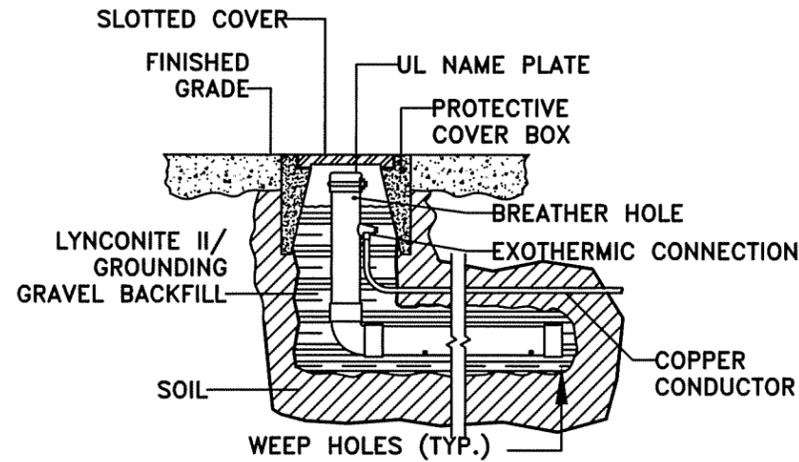
LYNCOLE XIT ROD DETAIL

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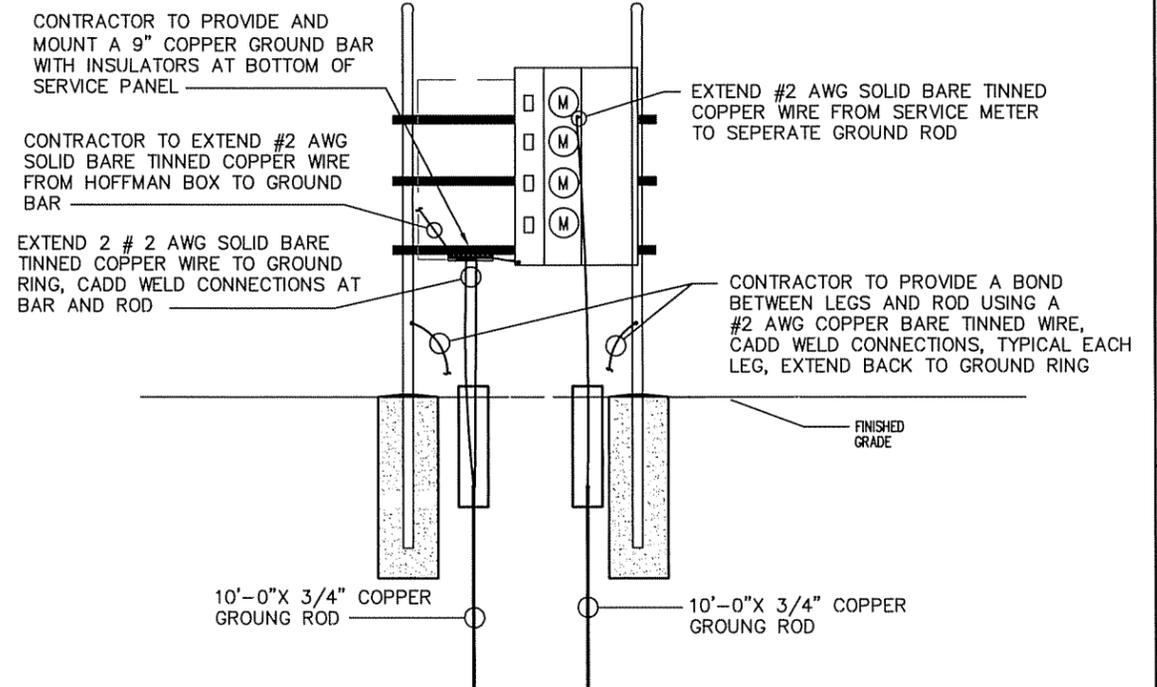
GROUND SLEEVE DETAIL

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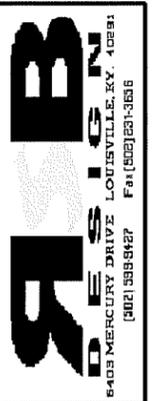
COAX SUPPORT DETAIL

NO SCALE

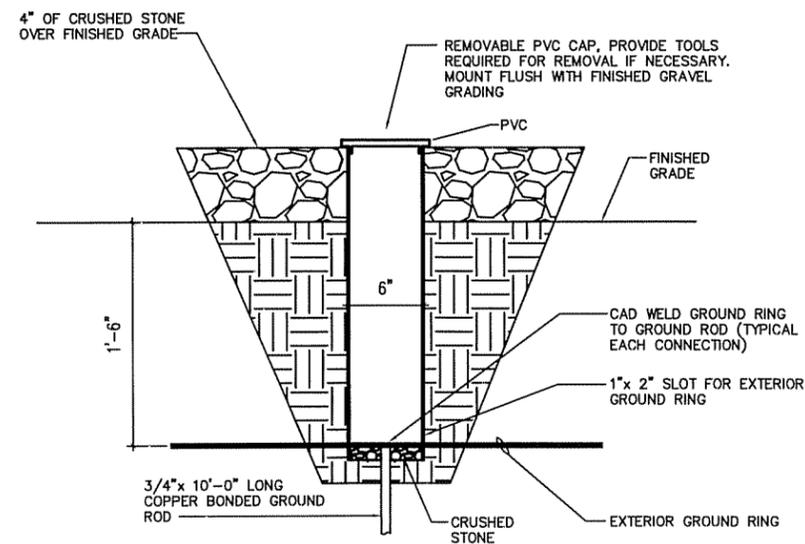

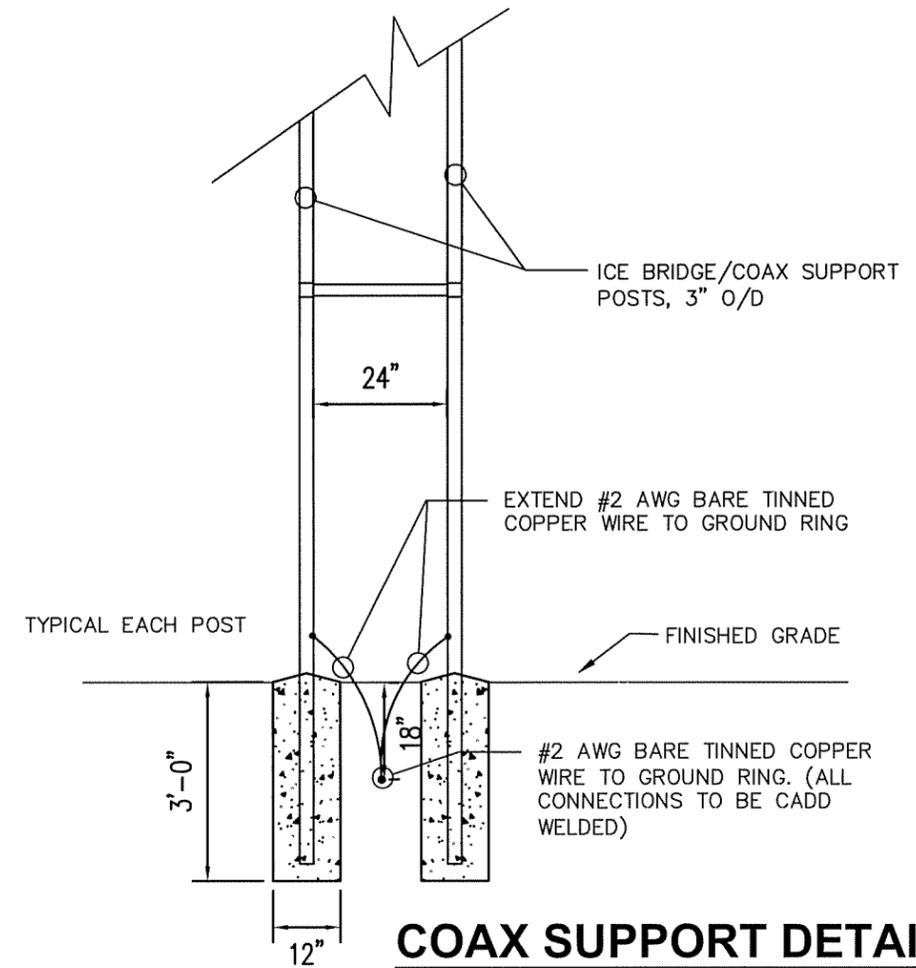SERVICE BOARD DETAIL

NO SCALE




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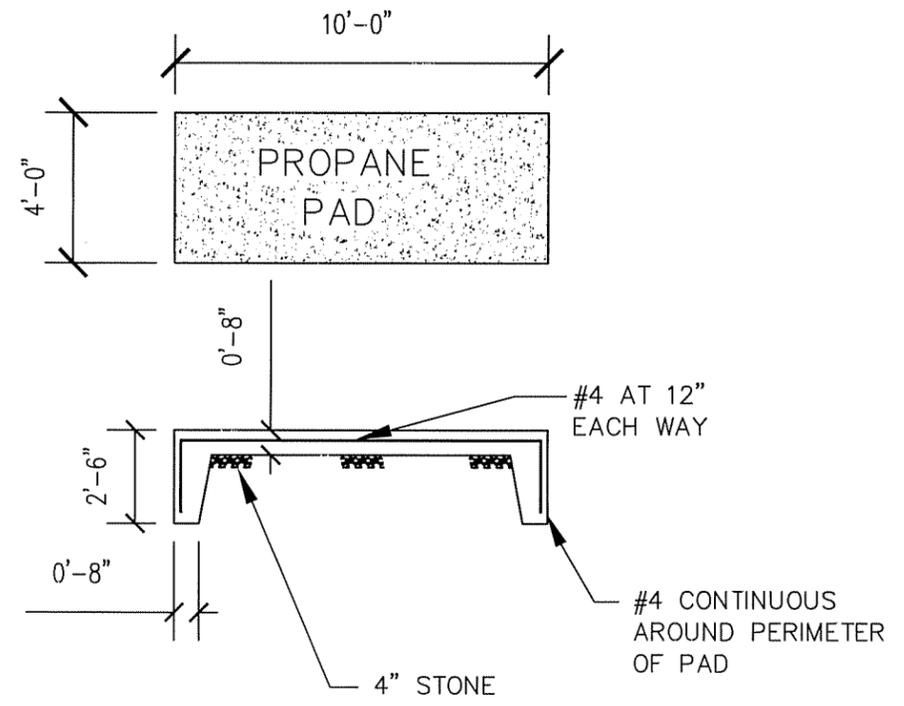
BLUEGRASS CELLULAR, INC.
STANDARD CELLULAR SITE
GREEN NORTH
788 SAND RIDGE RD. MAGNOLIA, KY. 42757

DRAWN BY: R. BECKER	ISSUE DATE: 1-14-08	SCALE: LISTED
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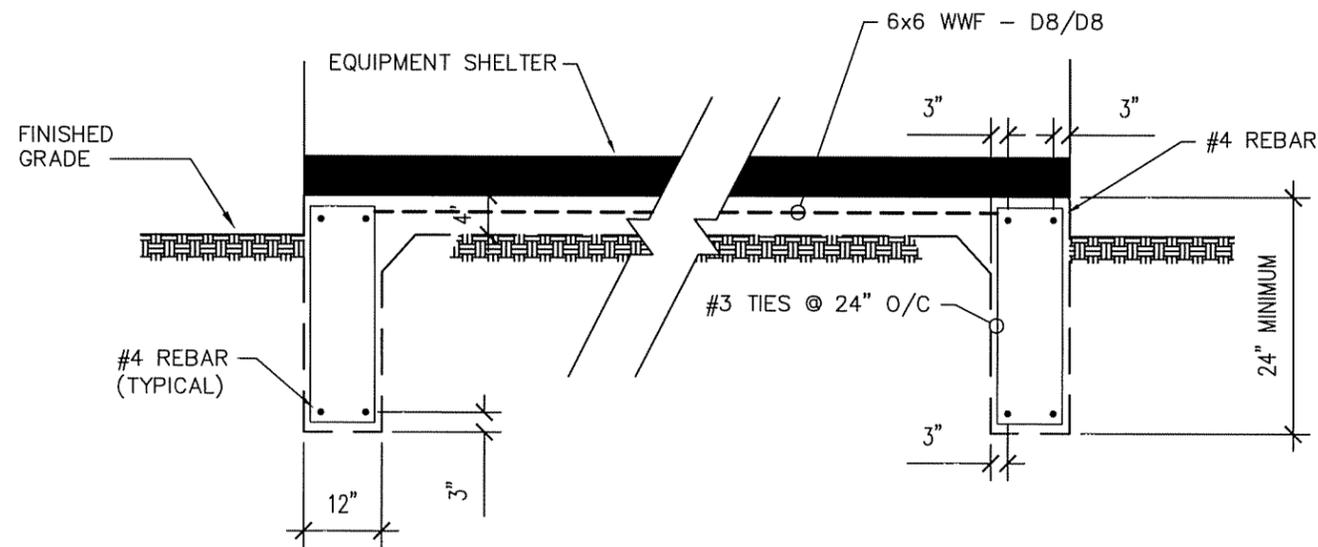
SHEET NUMBER
E-4




FOUNDATION DETAIL
NO SCALE

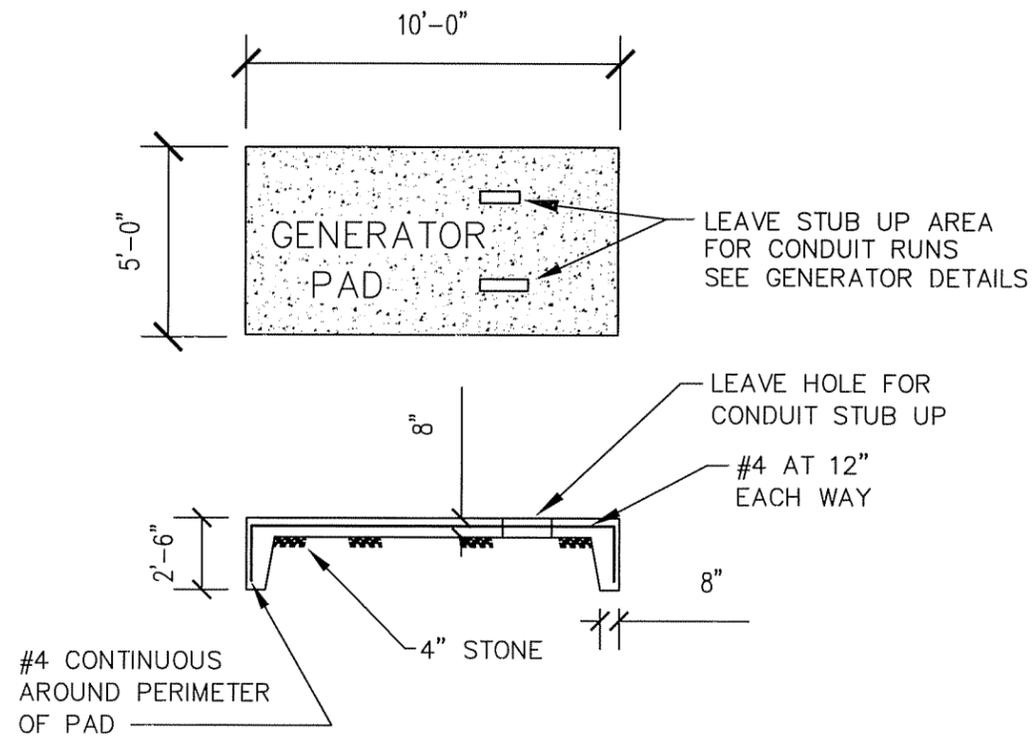

FOUNDATION DETAIL
NO SCALE



SHELTER FOUNDATION PLAN
NO SCALE

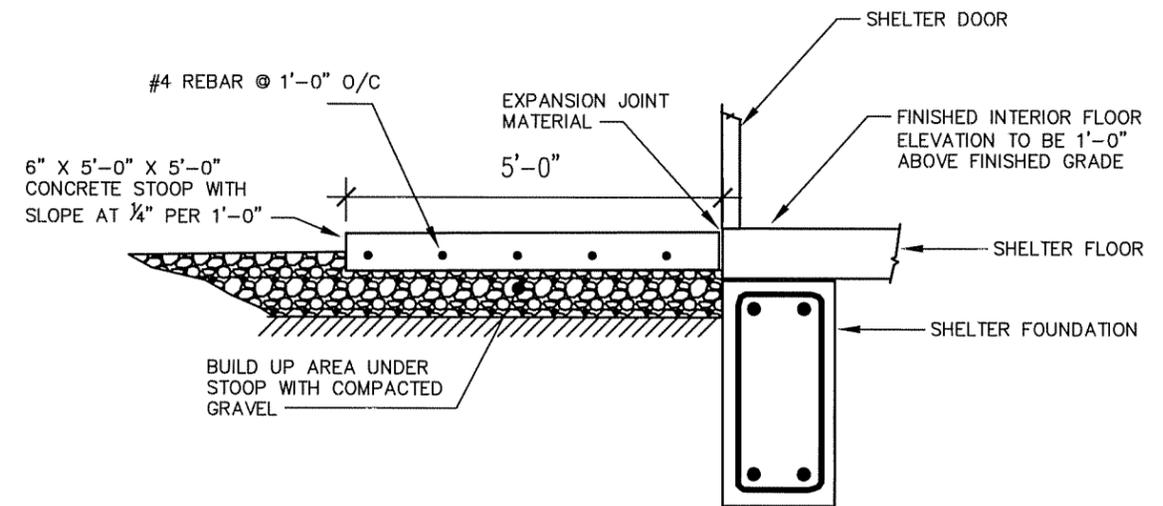

CONCRETE STOOP DETAIL
NO SCALE



BLUEGRASS CELLULAR, INC.
8400 MERCURY DRIVE LOUISVILLE, KY. 40241
(502) 999-9127 Fax (502) 991-9666


NO.	DATE	REVISION

BLUEGRASS CELLULAR, INC.
STANDARD CELLULAR SITE
GREEN NORTH
788 SAND RIDGE RD. MAGNOLIA, KY. 42757


DRAWN BY: R. BECKER
ISSUE DATE: 1-14-08
SCALE: LISTED

SHEET NUMBER
S-1

0G7627

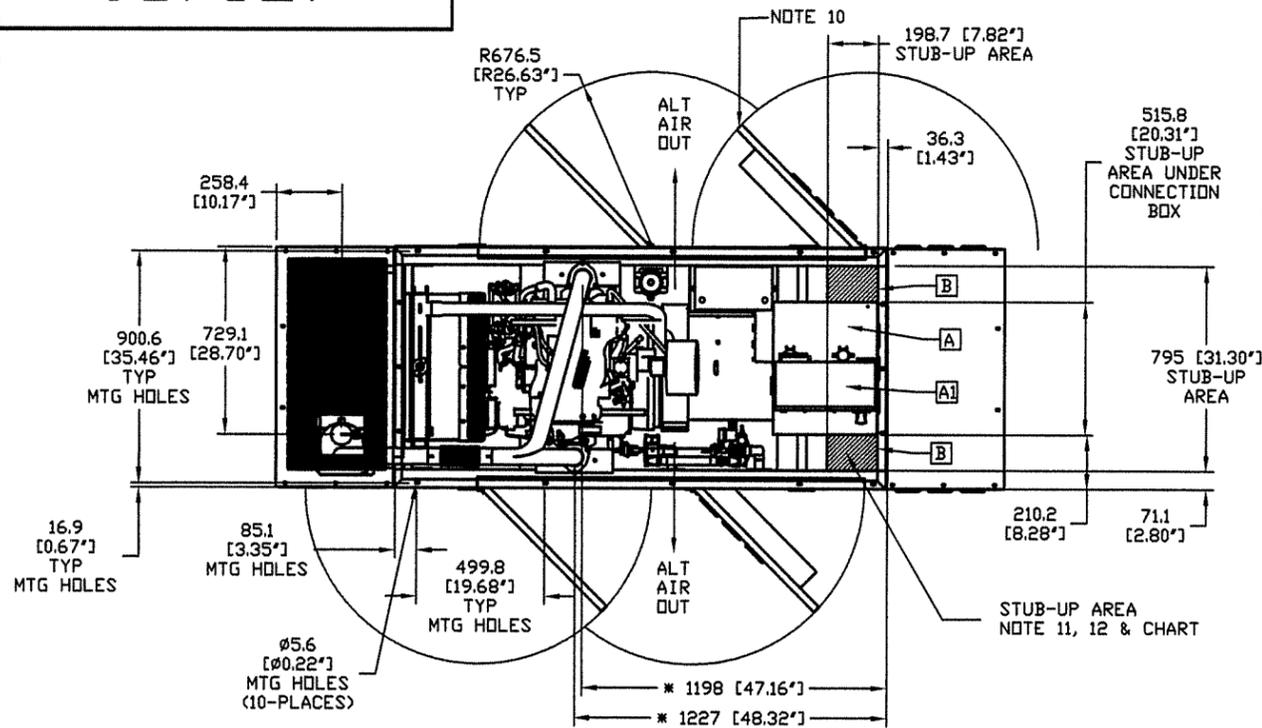

TOP OR PLAN VIEW

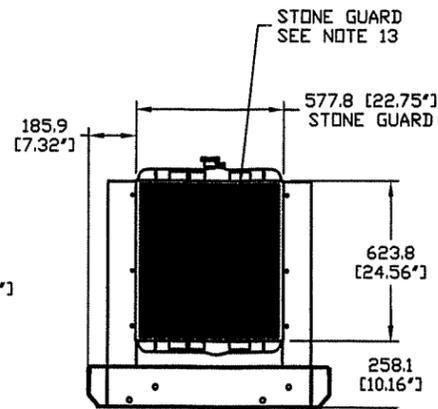

RADIATOR END VIEW WITH STONE GUARD OPTION

RECOMMENDED FUEL/ELECTRICAL STUB-UPS (SEE TOP VIEW)

DESCRIPTION	INSIDE BASE
AC LOAD LEAD CONDUIT (RIGHT)	A
AC LOAD LEAD CONDUIT (LEFT)	A ¹
ADDITIONAL STUB UP AREA FOR 120VAC GFCI OUTLET, (STANDARD BLOCK HEATER, BATTERY CHARGER, AND OTHER 120 VAC OPTIONS).	B

NOTE:
FUEL SYSTEM SET UP WITH OUTSIDE STUB-UPS (SEE RIGHT SIDE VIEW).

WEIGHT DATA
UNIT: ??? kg [??? lbs.]
STEEL ENCLOSURE: ??? kg [??? lbs.]


UNITS: mm [INCHES]

ENGINE SERVICE CONNECTIONS

INLET L/P GAS = 3/4" NPT COUPLING
INLET NATURAL GAS = 3/4" NPT COUPLING
OIL DRAIN = 1/2" NPT COUPLING
EXHAUST OUTLET - EXHAUST MANIFOLDS AS SHOWN ON OPEN SET, 3" OD MUFFLER OUTLET WITH ENCLOSURE


NOTES:

- CONTROL PANEL MAY BE ROTATED 180° IN EITHER DIRECTION.
 - STANDARD 20A GFCI DUPLEX OUTLET - 120VAC REQUIRED.
 - CONNECTION POINTS FOR CONTROL WIRES PROVIDED IN AC CONNECTION PANEL.
 - EXHAUST MUFFLER SUPPORT BRACKETS SUPPLIED WITH OPTIONAL ENCLOSURE.
 - 12 VOLT NEGATIVE GROUND SYSTEM.
 - 2.5" I.D. FLEX EXHAUST, STANDARD WITH ENCLOSURE UNITS, OPTIONAL WITHOUT.
 - MAIN LINE CIRCUIT BREAKER (MLCB) AND AC LOAD LEAD CONNECTION.
 - REMOVABLE BLANK PANEL FOR OPTIONAL 2nd MAIN LINE CIRCUIT BREAKER.
 - OPTIONAL ENCLOSURE.
 - DOORS MUST BE ABLE TO OPEN 90 DEG. TO BE REMOVED.
 - STUB-UPS: STANDARD BASE TANK REQUIRES ALL STUB-UPS TO BE OUTSIDE OR IN THE REAR TANK STUB-UP AREA.
 - A OR A¹ IS THE STUB UP AREA UNDER THE MLCB, DEPENDING ON CIRCUIT BREAKER LOCATION. AREA B IS STUB UP AVAILABLE FOR UNITS WITH A BASE TANK.
 - STONE GUARD AND AIR DUCT ADAPTER STANDARD WITH OPEN SET ONLY.
 - SEE DRAWING OC3850 FOR DUCT REMOVAL. REMOVAL OF FRONT DUCT WILL PROVIDE ACCESS TO MUFFLER FOR SERVICING.
- *NOTE: DIMENSIONS TO THE CENTER OF EXHAUST FLANGE SHOULD BE USED AS A REFERENCE WHEN EXHAUST SYSTEM IS NOT ORDERED. APPLIES TO OPEN SET ONLY.

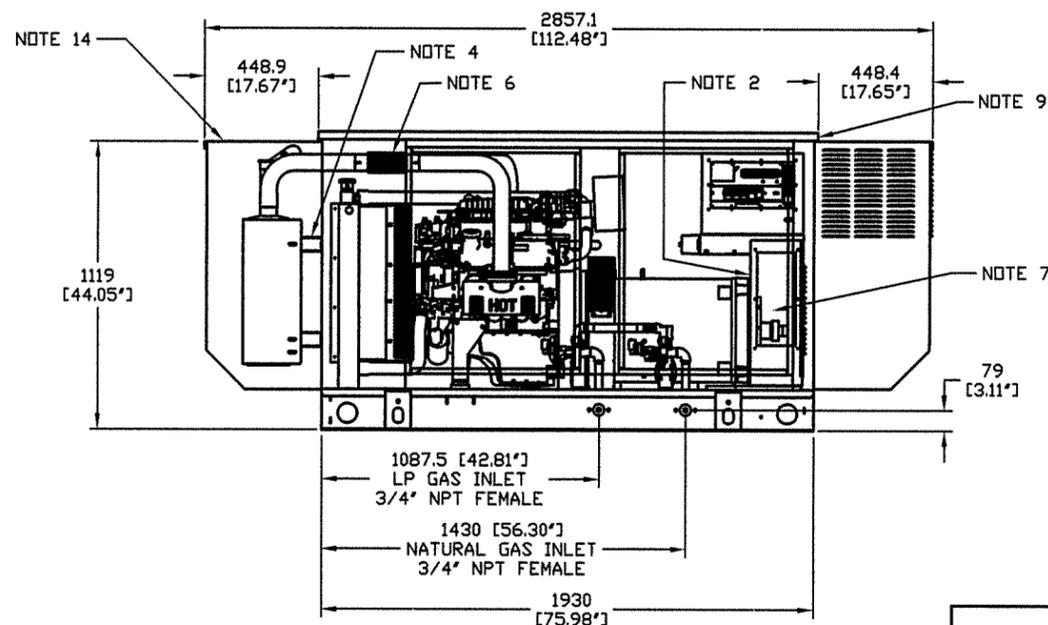


LEFT SIDE VIEW


APPLICABLE TO 4.5L G3 35, 40 & 45KW

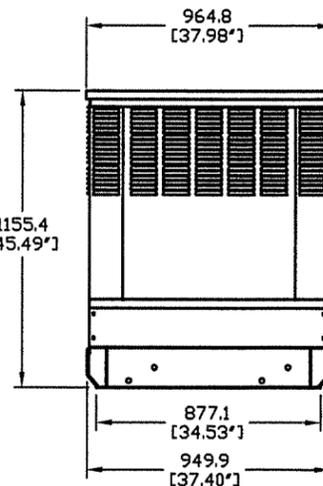

REAR VIEW

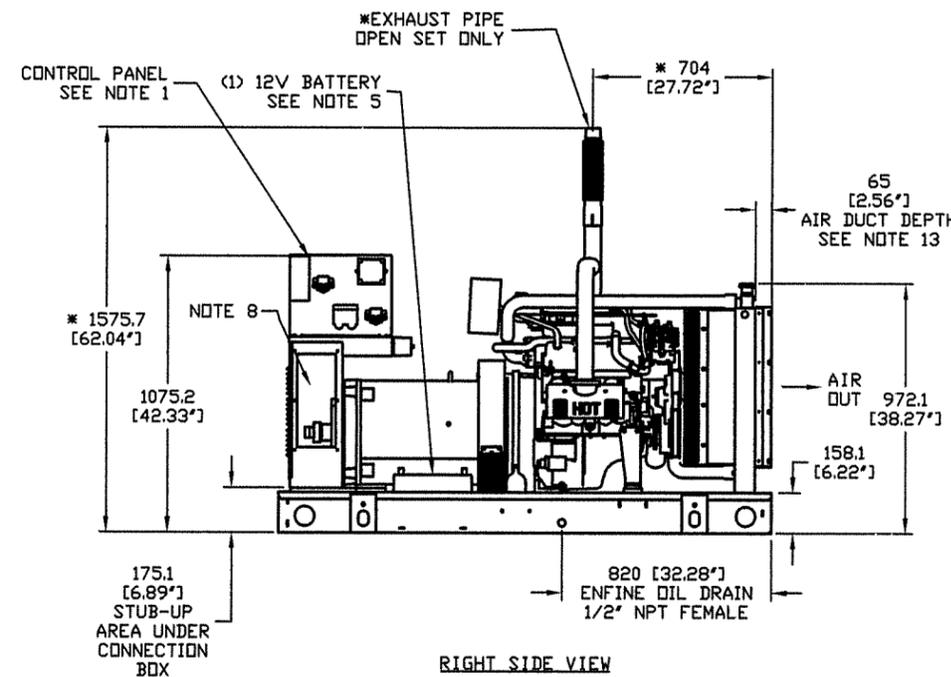

RIGHT SIDE VIEW

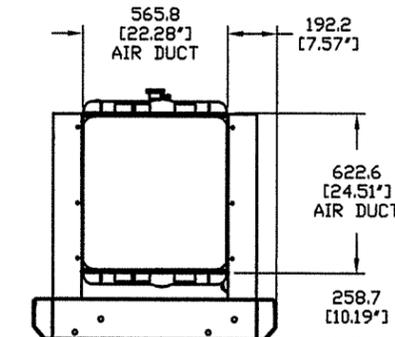

RADIATOR END VIEW WITH AIR DUCT ADAPTER OPTION

GENERAC POWER SYSTEMS OWNS THE COPYRIGHT OF THIS DRAWING WHICH IS SUPPLIED IN CONFIDENCE AND MUST NOT BE USED FOR ANY PURPOSE OTHER THAN FOR WHICH IT IS SUPPLIED WITHOUT THE EXPRESS WRITTEN CONSENT OF GENERAC POWER SYSTEMS.

© GENERAC POWER SYSTEMS 2001

SG 35, 40, 45 KW (UPSIZED 100 KW)

4.2L DIRECT DRIVE

ACOUSTIC ENCLOSURE

ISSUE DATE: 11/13/07

GENERAC POWER SYSTEMS
Waukesha
P.O. BOX 8
WAUKESHA, WIS. 53187

FILE NAME 0G7627-A.DWG SIZE B

SCALE NTS FIRST USE 4.2L G3

DWG NO. 0G7627 REV A

INSTALLATION DRAWING

GENERAL NOTES:

- 1) THE CONTRACTOR IS RESPONSIBLE FOR EQUIPMENT PICK UP DELIVERY TO SITE, ERECTION OF TOWER, AND CRANE SET, ALL COSTS INCURRED.
- 2) THE CONTRACTOR IS RESPONSIBLE FOR VISITING THE SITE PRIOR TO BIDDING AND REVIEWING EXISTING STRUCTURES OR UTILITIES THAT MIGHT BE LOCATED ON OR AROUND THE COMPOUND THAT COULD INTERFERE.
- 3) THE CONTRACTOR IS RESPONSIBLE FOR CONTACTING LOCAL AUTHORITIES NECESSARY FOR INSPECTIONS IF REQUIRED, PLEASE PROVIDE AMPLE NOTICE.
- 4) THE CONTRACTOR IS RESPONSIBLE FOR CONTACTING PERSONS RESPONSIBLE FOR ANY MATERIALS TESTING, PLEASE PROVIDE AMPLE NOTICE.
- 5) THE CONTRACTOR IS RESPONSIBLE FOR PROVIDING THE OWNER WITH FINAL TEST RESULTS ON ALL MATERIALS TESTING. IF ANY PROBLEMS ARE FOUND PRIOR TO FINAL RESULTS PLEASE NOTIFY A&E OR OWNER IMMEDIATELY.
- 6) THE CONTRACTOR IS RESPONSIBLE FOR ANY DAMAGE TO ADJOINING PROPERTY, AND REPAIRING OR REPLACING WHAT IS NECESSARY TO OWNERS APPROVAL.
- 7) THE CONTRACTOR IS TO VERIFY DIMENSIONS ON SITE PRIOR TO CONSTRUCTION STARTING, ANY PROBLEMS OR CHANGE FOUND CONTACT A&E OR OWNER TO VERIFY.
- 8) THE CONTRACTOR IS RESPONSIBLE FOR ANY TEMPORARY LIGHTING ON THE TOWER AND CONTACTING PROPER AUTHORITIES IF ANY LIGHTING PROBLEMS OCCUR, ALL FINAL LIGHTING TO BE MOUNTED ON TOWER DURING CONSTRUCTION, NOTIFY OWNER WHEN TOWER HAS REACHED FINAL HEIGHT.
- 9) THE CONTRACTOR IS RESPONSIBLE FOR ALL ON SITE WORK MEANS AND METHODS.
- 10) CONTRACTOR, ANY CONTRACTOR EMPLOYEES OR REPRESENTATIVES, OR SUB-CONTRACTOR, ANY SUB-CONTRACTOR EMPLOYEES OR REPRESENTATIVES, WILL CONFORM TO ALL LAWS AND REGULATIONS APPLICABLE TO THE WORK BEING PERFORMED, INCLUDING BUT NOT LIMITED TO, ALL OCCUPATIONAL SAFETY AND HEALTH ACT ("OSHA") STATUTES AND REGULATIONS AS WELL AS ALL OTHER FEDERAL, STATE AND/OR LOCAL LAWS OR REGULATIONS APPLICABLE TO THE WORK BEING PERFORMED BY CONTRACTOR.
- 11) THE CONTRACTOR IS RESPONSIBLE FOR MAINTAINING ALL SITE DRAINAGE, AND PROVIDING SILT AND EROSION CONTROL NECESSARY TO MAINTAIN ANY RUN OFF.
- 12) THE CONTRACTOR IS RESPONSIBLE FOR ALL SEED AND STRAW WORK NECESSARY TO REPAIR DAMAGED AREAS.
- 13) CONTRACTOR TO GRADE SMOOTH OR REPAIR ANY POT HOLES OR DITCHING ON PROPERTY OR ROAD THAT HAS OCCURRED DURING CONSTRUCTION AT CONTRACTORS EXPENSE.
- 14) CONTRACTOR'S RESPONSIBILITIES REGARDING BUILD OUT ON FIBREBOND EQUIPMENT SHELTERS TO INCLUDE:
 - * INSTALLING THE DOOR CANOPY
 - * INSTALLING EXTERIOR LIGHT ON WALL DETERMINED BY PROJECT SUPERVISOR AND PHOTOCCELL REQUIREMENTS
 - * INSTALLING INTRUDER ALARMS
 - * CHECK OPERATIONS OF DOOR AND DOOR HARDWARE
 - * ADJUST WEATHERSTRIPPING ON DOORS AS NEEDED
 - * INSPECT ROOF FOR DAMAGE AND POSSIBLE LEAKS
 - * INSPECT INTERIOR FINISH FOR IMPERFECTIONS AND REPAIR AS NEEDED
 - * CHECK OPERATION OF LIGHTS AND ELECTRICAL OUTLETS
 - * CHECK OPERATION OF INTAKE AND EXHAUST LOUVERS AND ADJUST AS NEEDED
 - * CHECK OPERATION OF ENVIRONMENTAL CONTROLS AND HVAC UNITS
 - * INSTALL AND PAINT SHELTER TIE-DOWNS TO MATCH
- 15) INSTALL CONCRETE PADS FOR BUILDING, PROPANE TANK, GENERATOR PAD.
- 16) INSTALL ELECTRIC AND GROUND FIELD FOR COMPOUND.

- 17) GC WILL BE RESPONSIBLE FOR ALL CRANE OPERATIONS IN ORDER TO SET FIBREBOND BUILDING. COORDINATE BUILDING DELIVERY DATE THROUGH BLUEGRASS CELLULAR.
- 18) GC WILL BE RESPONSIBLE FOR OFF LOADING AND STACKING OF TOWER WHEN APPLICABLE.
- 19) GC WILL BE RESPONSIBLE FOR MOUNTING ALL LINES AND ANTENNAS.
- 20) GC WILL BE RESPONSIBLE FOR SUPPLYING AND INSTALLING ICE BRIDGE.
- 21) GC WILL BE RESPONSIBLE FOR SCHEDULING PROPANE TANK DELIVERY AND HOOK-UP.
- 22) GC WILL BE RESPONSIBLE FOR COORDINATING THE CLEANING OF THE INSIDE OF THE BUILDING WITH THE PROJECT SUPERVISOR AFTER THE SITE HAS BEEN TURNED OVER TO THE OPERATIONS DEPARTMENT AND ALL TURN-UP PROCEDURES HAVE BEEN COMPLETED. THIS WILL INCLUDE SUPPLYING A 30 GALLON TRASHCAN, 30 GALLON TRASH BAGS, BROOM, DUST PAN AND DOORMAT FOR BUILDING.
- 23) GC TO VERIFY ALL BLUEGRASS CELLULAR EQUIPMENT DIMENSIONS & SPECIFICATIONS WITH MANUFACTURER'S DRAWINGS, (FIBREBOND, GENERAC, EASTPOINTE ETC.) PRIOR TO CONSTRUCTION. ADDRESS ANY ISSUES WITH PROJECT SUPERVISOR BEFORE WORK BEGINS.
- 24) ALL WAREHOUSE MATERIAL (LINES, ANTENNAS, MOUNTING HARDWARE, GENERATOR, TOWER FOUNDATION KIT, ETC.) WILL NEED TO BE PICKED UP BY GC.
- 25) GC WILL BE RESPONSIBLE FOR SCHEDULING GENERATOR START-UP WITH CONTACT SCOTT ANDERSON (EVAPAR) 502-267-6315
- 26) T1 CONDUIT WILL NEED TO BE PLACED FROM POLE TO BUILDING. (IF A MICROWAVE DISH IS USED, THE T1 CONDUIT WILL STILL BE INSTALLED FOR FUTURE USE.)
- 27) GC WILL BE RESPONSIBLE FOR INSTALLATION OF ALL FENCING.
- 28) ALL TRASH AND DEBRIS TO BE REMOVED BY GC
- 29) GC WILL BE RESPONSIBLE FOR APPLYING FOR ELECTRICAL SERVICE AND PAYING NECESSARY FEES REQUIRED.
- 30) GC WILL BE RESPONSIBLE FOR SUPPLYING & INSTALLING PROTECTIVE END CAPS ON ANY EXPOSED THREADED ROD OR UNISTRUT USED ON SITE. VERIFY TYPE WITH PROJECT SUPERVISOR PRIOR TO INSTALLATION.
- 31) GC WILL BE RESPONSIBLE FOR HAVING A CERTIFIED ELECTRICIAN HOOK UP THE BATTERIES (IMMEDIATELY) AFTER POWER HAS BEEN TURNED UP AT THE SITE, PREVENTING THE DELAY OF ANY WORK FOR OPERATIONS. THE GENERAL CONTRACTOR MUST NOTIFY THE PROJECT SUPERVISOR IMMEDIATELY AT THIS TIME SO HE CAN COORDINATE A CELL TECH TO BE ONSITE WHEN THIS OCCURS.
- 32) GC WILL BE RESPONSIBLE FOR RUNNING (CAT5) FROM THE GENERATOR ALARM PANEL MOUNTED ON THE SIDE OF THE TRANSFER SWITCH (BY THE CONTRACTOR), THROUGH THE TRANSFER SWITCH AND UP TO THE EXISTING CONDUIT BESIDE THE A/C POWER FAIL RELAY. THE (CAT5) WILL BE PULLED THROUGH EXISTING CONDUIT AROUND THE SHELTER AND EXTENDED TO THE ALARM BLOCK. THERE SHOULD BE A MINIMUM 3'-0" OF (CAT5) LEFT HANGING ON EACH END FOR THE CELL TECH TO HOOK UP THE GENERATOR ALARMS.
- 33) GC MUST SUBMIT A COPY OF THE BUILDING PERMIT AND CONSTRUCTION SCHEDULE TO THE PROJECT SUPERVISOR PRIOR TO RECEIVING (NTP) TO BEGIN CONSTRUCTION (NO EXCEPTIONS).







GRADING & EXCAVATING NOTES:


- 1) ANY DAMAGE TO EXISTING UTILITIES, STRUCTURES, ROADS AND PARKING AREAS TO BE REPAIRED OR REPLACED TO OWNERS SATISFACTION.
- 2) PREPARATION FOR FILL: REMOVAL OF ALL DEBRIS, WET AND UNSATISFACTORY SOIL MATERIALS, TOPSOIL, VEGETATION, AND HARMFUL MATERIALS FROM SURFACE OF GROUND PRIOR TO PLOWING, STRIPPING, PLACING FILLS OR BREAKING UP OF SLOPED SURFACES GREATER THAN 1 VERTICAL TO 4 HORIZONTAL SO MATERIAL FOR FILL WILL BOND TO EXISTING SURFACE. WHEN AREA TO RECEIVE FILL HAS A DENSITY LESS THAN REQUIRED, BREAK UP GROUND SURFACE TO DEPTH REQUIRED, AERATE, MOISTURE - CONDITION, OR PULVERIZE SOIL AND RECOMPACT TO REQUIRED DENSITY.
- 3) BACK FILLING:
 - EXCAVATED AREA SHALL BE CLEARED FROM STONES OR CLODS OVER 2 1/2" MAXIMUM DIAMETER
 - SHALL BE PLACED IN LAYERS OF 6" AND COMPACTED TO A 95% STANDARD PROCTOR, USE A 90% PROCTOR IN GRASSED / LANDSCAPED AREAS WHERE REQUIRED.
 - SHALL BE APPROVED MATERIALS CONSISTING OF SANDY CLAY, GRAVEL AND SAND, SOFT SHALE, EARTH OR LOAM. CONSULT WITH OWNER PRIOR TO FILL BEING ADDED.
- 4) ALL MATERIAL FOR FILL TO BE APPROVED BY OWNER AND ALL COMPACTING TEST TO BE COMPLETED TO SPEC'S ALL COMPACTING RESULTS TO BE TURNED OVER TO OWNER.
- 5) AFTER COMPLETION OF BELOW GRADE EXCAVATING, AREA TO BE CLEANED AND CLEARED OF ANY UNSUITABLE MATERIALS, SUCH AS TRASH, DEBRIS, VEGETATION AND SO FORTH.
- 6) ANY EXCAVATING IN WHICH CONCRETE IS TO BE PLACED SHALL BE SUBSTANTIALLY HORIZONTAL ON UNDISTURBED AND UNFROZEN SOIL AND BE FREE OF ANY LOOSE MATERIAL AND EXCESS GROUND WATER.
- 7) IF SOUND SOIL IS NOT REACHED AT DESIGNATED EXCAVATION DEPTH, THE POOR SOIL IS TO BE EXCAVATED TO ITS FULL DEPTH AND EITHER REPLACED WITH MECHANICALLY COMPACTED GRANULAR MATERIAL OR THE EXCAVATION TO BE FILLED WITH THE SAME QUALITY CONCRETE SPECIFIED FOR THE FOUNDATION. PLEASE NOTIFY THE PROJECT SUPERVISOR AND THEY WILL HAVE A 3RD PARTY ENGINEERING FIRM CONTACT YOU WITH RECOMMENDATIONS.
- 8) MECHANICALLY COMPACTED GRANULAR MATERIAL OR CONCRETE OF THE SAME QUALITY SPECIFIED FOR THE FOUNDATIONS TO BE USED IF EXCAVATION EXCEEDED THE OVERALL REQUIRED DEPTH. FOR STABILIZATION OF THE BOTTOM OF THE EXCAVATION, CRUSHED STONE MAY BE USED. STONE, IF USED, SHALL NOT BE USED AS COMPILING CONCRETE THICKNESS. PLEASE NOTIFY THE PROJECT SUPERVISOR AND THEY WILL HAVE A 3RD PARTY ENGINEERING FIRM CONTACT YOU WITH RECOMMENDATIONS.
- 9) EXCAVATION TO COMPOUND TO INCLUDE WEED CONTROL MAT.
- 10) SITE TO HAVE PROPER DRAINAGE & EROSION CONTROL (CROWNED FORMATION)
- 11) GC WILL BE RESPONSIBLE FOR REPAIR OF ALL AREAS DISTURBED DURING CONSTRUCTION. (EXCAVATING ISSUES)

"BEFORE YOU DIG"

THE CONTRACTOR'S ATTENTION IS DIRECTED TO THE UTILITY PROTECTION CENTER, PHONE 1-800-752-6007, WHICH WAS ESTABLISHED TO PROVIDE ACCURATE LOCATIONS OF UNDERGROUND UTILITIES. THE CONTRACTOR SHALL NOTIFY THE UTILITY PROTECTION CENTER 48 HOURS IN ADVANCE OF ANY CONSTRUCTION ON THIS PROJECT. ALL NEW SERVICE AND GROUNDING TRENCHES PROVIDE A WARNING TAPE @ 12 INCHES BELOW GRADE.

SYMBOLS LEGEND

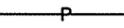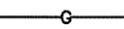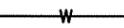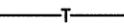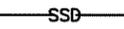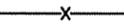-  KEYNOTE
-  INSPEC. SLEEVE / GRND ROD
-  INSPECTION SLEEVE
-  CAD WELD CONNECTION
-  TRANSFORMER
-  LIGHTNING SUPPRESSOR
-  SWITCH (DISCONNECT)
-  METER PACK
-  POWER
-  GAS LINE
-  WATER LINE
-  SANITARY SEWER
-  TELEPHONE
-  STORM SEWER DRAIN
-  FENCE

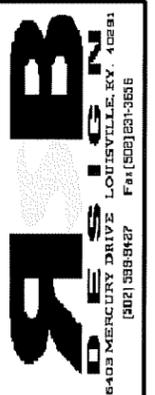

NO.	DATE	REVISION

BLUEGRASS CELLULAR, INC.
STANDARD CELLULAR SITE
GREEN NORTH
 788 SAND RIDGE RD. MAGNOLIA, KY. 42757


DRAWN BY: R. BECKER
 ISSUE DATE: 1-14-08
 SCALE: LISTED

SHEET NUMBER
General Notes

C

Landmark Surveying Co., Inc.

Darren L. Helms, R.L.S., PRESIDENT
Dennis N. Helms, R.L.S., VICE PRESIDENT

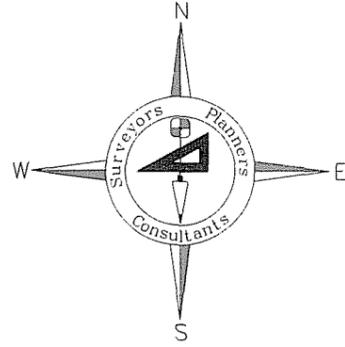

15 N.E. 3rd Street
Washington, Indiana 47501
Phone: 812-257-0950
Fax: 812-257-0953
E-mail: landmark@dmrtc.net

Directions to the Site From the County Seat of Green County, Kentucky

Green North Site
Green County, Kentucky

From downtown Greensburg, Kentucky: travel north on Kentucky Highway 61 for 16.8 miles to Bird Road at the Green/LaRue County Line; turn left onto Bird Road and travel southerly for 0.5 miles to Sand Ridge Road; continue southerly on Sand Ridge Road for 0.8 miles to the tower site on the left or east side of the road in a wooded area. The address of the site is 788 Sand Ridge Road, Magnolia, KY 42757.

Darren L. Helms
Darren L. Helms, Kentucky Professional Land Surveyor No. 3386

Nov. 26, 2007
Date



Site Name: Green North

OPTION TO LEASE AND LEASE AGREEMENT

I.

OPTION TO LEASE REAL PROPERTY

THIS OPTION TO LEASE REAL PROPERTY (the "Option Agreement") is made and entered into this 4 day of October, 2007, by and between Floyd Evans and Sandra Evans, husband and wife whose address is 600 Mt. Sherman-Ward Road, Magnolia, KY 42757 (the "Optionor (s)" and Kentucky RSA 4 Cellular General Partnership, d/b/a Bluegrass Cellular, a Kentucky general partnership with principal office and place of business at 2902 Ring Road, Elizabethtown, KY 42701 (the "Optionee").

WITNESSETH:

WHEREAS, the Optionor(s) is the owner of certain real property located in Green County, **Kentucky** as more particularly described on Exhibit A attached hereto and incorporated herein by reference (the "Property"); and

WHEREAS, the Optionor(s) wishes to grant to the Optionee, and the Optionee wishes to obtain from the Optionor(s), an option to lease the Property upon the terms and conditions set forth herein;

NOW, THEREFORE, in consideration of the foregoing premises and for other good and valuable consideration, the mutuality, receipt and sufficiency of which are hereby acknowledged, the parties hereto do agree as follows.

Site Name: Green North

1. In consideration of **One Thousand Eight Hundred Dollars and Zero Cents (\$1,800.00)** paid by the Optionee to the Optionor(s) (the "Option Consideration"), the receipt of which is hereby acknowledged by the Optionor(s), the Optionor(s) hereby grants to the Optionee an exclusive and irrevocable option to lease the Property (the "Option"), upon the terms and conditions hereinafter set forth, upon the exercise of the Option at any time before 4:00 p.m. prevailing time on 21 Mar 09 (the "Option Period") as set forth in Paragraph 5 thereof.
2. The parties hereto anticipate that the Property comprises approximately a **One Hundred Foot by One Hundred Foot** area, and that a right of way will be given by the Optionor(s) for the purposes of ingress and egress throughout the term of the lease. The Optionee shall obtain an accurate survey of the Property by a registered land surveyor licensed in the Commonwealth of Kentucky at the sole expense of the Optionee. A copy of the survey shall be provided to the Optionor(s). The description of the Property shall include the number of acres determined by the surveyor. The Optionee shall obtain said survey within a reasonable time following the date of the Option Agreement.
3. During the term of the Option, the Optionee may enter onto the Property at its own risk to obtain soil samples and to bore soil for the purposes of determining the suitability of the Property for a communications tower.
4. Upon the Optionee's proper exercise of the Option in accordance with Paragraph 5 hereof, the Optionor(s) shall be deemed to have immediately executed, acknowledged and delivered to the Optionee the Lease Agreement contained in Section II hereof. The description of the Property shall be that determined by the registered land surveyor in accordance with Paragraph 2 hereof.

Site Name: Green North

5. If the Optionee elects to exercise the Option in accordance with the terms hereof, notice of such election shall be deemed sufficient if personally delivered or sent by registered or certified mail, return receipt requested, to the address of the Optionor(s) set forth in Paragraph 14 hereof.
6. The Optionor(s) agrees not to sell, lease or offer for sale or lease the Property during the term of this Option or any renewal or extension of the Option.
7. In the event the Optionee fails to exercise the Option as set forth herein (unless such failure is due to the discovery of a defect in the Property or other matter unsatisfactory to the Optionee), the Optionor(s) shall have the right to retain the Option Consideration.
8. The Optionee may assign this Option with written consent of the Optionor(s), which consent shall not be unreasonably withheld, and upon any assignment such assignee shall have all the rights, remedies and obligations as if it were the original Optionee hereunder. From and after any such assignment, the term "Optionee" shall refer to such assignee.
9. Each party hereto shall bear any and all of its own expenses in connection with the negotiation, execution or settlement of this Option.
10. Risk of loss with respect to the Property during the term of this Option and during the term of the lease shall be upon the Optionor(s). If, during the term of the Option, any portion of the Property shall be acquired by public authority under the right or threat of eminent domain, the Optionee may, at its sole option, either (i) exercise the

Site Name: Green North

Option, and in such event, all sums received from the public authority by the Optionor(s) by reason of the taking of a portion of the Property shall reduce the rent due under the lease, or (ii) terminate this Option and thereupon the Optionor(s) shall be obligated to return to the Optionee the full amount of the Option Consideration previously paid to the Optionor(s) in "good and collected funds."

11. The parties hereto represent to each other that neither has engaged any broker to represent their interests in connection with the transactions contemplated hereby, and each agrees to indemnify the other against any and all claims made by any brokers engaged or purported to be engaged by the other for brokerage commissions or fees in connection with the transactions contemplated hereby.
12. The Optionor(s) represents, warrants and covenants to the Optionee that the Optionor(s) has not caused or permitted, and shall not cause or permit, and to the best of Optionor(s)' knowledge no other person has caused or permitted any hazardous material (as defined by any applicable federal, state or local law, rule or regulation) to be brought upon, placed, held, located or disposed of at the Property. In the event any such contamination occurs for which the Optionee becomes legally liable, the Optionor(s) shall indemnify the Optionee against all claims, damages, judgments, penalties and costs and expenses, including reasonable attorneys' fees, which Optionee may incur.
13. This Option Agreement and the rights and obligations of the parties hereto shall be construed in accordance with the laws of the Commonwealth of Kentucky.

Site Name: Green North

14. For the purposes of giving notice as permitted or required herein, the address of the Optionor(s) shall be: **600 Mt. Sherman-Ward Rd., Magnolia, KY 42757**; the Optionee's address shall be: **2902 Ring Road, Elizabethtown, KY 42701**. Any inquiry by the Optionor to the Optionee regarding the terms and conditions of the Option Agreement or Lease Agreement, or otherwise related to the Option Agreement or Lease Agreement, shall be made in writing and submitted to the attention of the Optionee's Lease Administrator at the above address.
15. The Optionee shall have the right, in its sole discretion, to record this Option in the Office of the Clerk of the County Court of Green County, **Kentucky**.

II.

LEASE AGREEMENT

16. In the event the Optionee elects to exercise the Option to lease the Property, the terms of the Lease Agreement ("Lease Agreement" or "Lease") shall become immediately effective upon such exercise and shall be as follows.
 1. The term of the Lease shall commence on the date that the Optionor(s) receives proper notice that the Optionee has exercised the Option, pursuant to Paragraph 5 therein. The initial term shall expire **five (5) year(s)** from the commencement date of the Lease Agreement and shall include **six (6) additional five (5)-year terms** per the Lease Agreement. Optionee may, by providing written notice at least sixty (60) days prior to the expiration of the original or any renewal Lease term, elect to unilaterally terminate this Lease at the end of any original or renewal Lease term. Such notice must be

Site Name: Green North

personally delivered or sent via registered or certified mail, return receipt requested, to the address of the Optioner(s) set forth in Paragraph 14 hereof. The Lease amount shall be adjusted at the end of each term by an increase of 12%.

2. The Optionee shall pay to the Optionor(s) rent for the Property in the sum of Four Thousand Eight Hundred Dollars and Zero Cents (\$4,800.00) yearly, to be paid in advance. All rent payments shall be personally delivered or mailed to the Optionor(s) at the address set forth in Paragraph 14 hereof. Any check payment of the rent due under the Lease shall be payable to the order of Optionor(s).
3. The Optionee shall be entitled to use and occupy the Property for the purpose of erecting, maintaining and operating a communications tower and communications facilities thereon and for all such other uses as Optionee may, in its sole discretion, deem necessary in connection therewith.
4. The Optionor(s) shall be responsible for the payment of all real estate taxes which shall be assessed against the Property during the term of the lease. The Optionee shall pay all charges for heat, water, gas, electricity, sewer use charges and any other utility used or consumed on the Property. The Optionee shall, at its own cost and expense, maintain and keep in full force and effect during the term of the lease public liability insurance with coverage in the amount of at least one million dollars (\$1,000,000.00) per person for bodily injury, disease, or death and shall maintain property insurance on any property the Optionee located on the Property.

Site Name: Green North

5. The Optionee may assign the lease. The Optionee may sublet all or part of the space on the tower or ground space.
6. The Optionor(s) covenants that upon the Optionee's payment of the rent agreed upon herein, as well as Optionee's observing and performing all of the covenants and conditions contained in the Lease, the Optionee may peacefully and quietly enjoy the Property subject to the terms and conditions set forth in the Lease.
7. The Optionee agrees to maintain an access road in a passable manner for the term of the lease.
8. Licensee's Payment of Taxes, Fees and Assessments. Optionee shall pay directly to the applicable federal, state or local governmental unit or agency ("Governmental Entity") or to Optionor if Optionor is invoiced by such Governmental Entity, all taxes, fees, assessments or other charges assessed by any Governmental Entity directly against Optionee's Equipment and/or Optionee's use of the Facility. Optionee shall also pay to Optionor Optionee's Pro Rata Share of all taxes, fees, assessments or charges including, but not limited to, personal property taxes attributable to Optionee's equipment and antenna(s), municipal franchise fees, use fees, municipal application fees, installation fees and increases thereof. "Pro Rata Share" shall mean the fraction of decimal equivalent of dividing one (1) by the total number of then existing users occupying a tower on the last day of the applicable calendar year.

Site Name: Green North

17. This Option and Lease Agreement contains the entire agreement between the parties hereto and no modification or amendment shall be binding upon any party unless made in writing and signed by each of the parties hereto.
18. Upon the termination or other end of this Lease Agreement, Optionee shall have the right to remove any and all of its property (real or personal) from the Property regardless of whether or not such property may be considered a fixture thereto.
19. Upon abandonment of the property, Optionee shall have thirty (30) days to dismantle and remove the cellular antenna tower and any/all equipment located on Optionor's property.

[Remainder of Page Intentionally Left Blank]

Site Name: Green North

EXECUTION OF AGREEMENT(S)

IN WITNESS WHEREOF, the parties hereto have set their hands and affixed their respective seals.

Floyd Evans
Date: 9-21-07

Kentucky RSA 4 Cellular General Partnership,
d/b/a Bluegrass Cellular, a Kentucky general
partnership

Sandra Evans
Date: 9-21-07

Ron Smith
Date: 10-4-7

("Optionor(s)")

("Optionee")

By: **Floyd Evans and Sandra Evans**
Property Owner(s)

By: **Ron Smith**
Authorized Representative

STATE OF Ky
COUNTY OF LARUE


The foregoing instrument was acknowledged before me this 21st day of September, 2007, by Floyd Evans to be his/her free act and deed.

James J. Whitten
NOTARY PUBLIC STATE AT LARGE
My commission expires: 1-25-10

Site Name: Green North


STATE OF Ky
COUNTY OF Larue

The foregoing instrument was acknowledged before me this 21st day of September,
2007, by Sandra Evans to be his/her free act and deed.

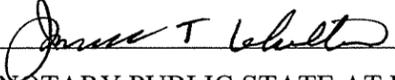

NOTARY PUBLIC STATE AT LARGE
My commission expires: 1-25-10


STATE OF KENTUCKY
COUNTY OF HARDIN

The foregoing instrument was acknowledged before me this 4 day of October,
2007, by **Ron Smith**, to be his free act and deed.

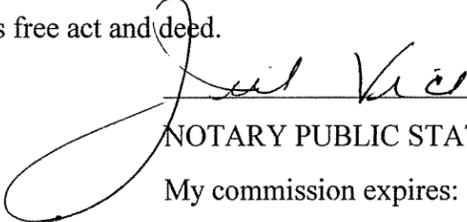
NOTARY PUBLIC STATE AT LARGE
My commission expires: 1-21-09

This instrument prepared by:

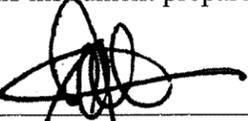
John L. Selent
DINSMORE & SHOHL LLP
1400 PNC Plaza
500 West Jefferson Street
Louisville, KY 40202
(502) 540-2300

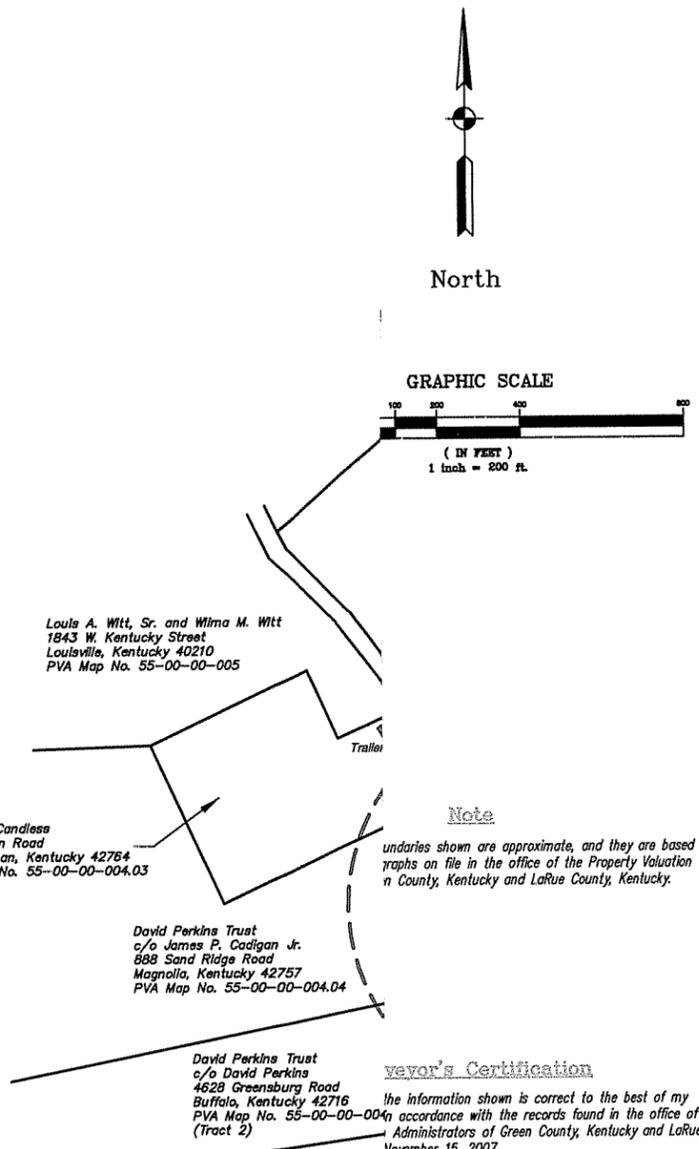

Note
Boundaries shown are approximate, and they are based on graphs on file in the office of the Property Valuation in County, Kentucky and LaRue County, Kentucky.

Surveyor's Certification
The information shown is correct to the best of my knowledge in accordance with the records found in the office of the Administrators of Green County, Kentucky and LaRue County, Kentucky.
November 15, 2007.

David Perkins
c/o David Perkins
4628 Greensburg Road
Buffalo, Kentucky 42716
PVA Map No. 55-00-00-004.03 (Tract 3)

D. Helms
2007

STATE OF KENTUCKY
DARREN L. HELMS
3386
LICENSED PROFESSIONAL LAND SURVEYOR

Landmark Surveying Co., Inc.
15 N.E. 3rd Street
Washington, Indiana 47501
(812) 257-0850
Email: landmark@landmarksurvey.com
Project No. 07-11-0180

500-Foot Radius Map
788 Sand Ridge Road
Magnolia, Kentucky 42757

Bluegrass Cellular
2902 Ring Road
Elizabethtown, Kentucky 42701

REVISIONS	DATE

DATE 11-26-07	DRAWN BY A. Winkler	CHECKED BY D.L. Helms
------------------	------------------------	--------------------------

SHEET NO.
1
OF 1 SHEETS
FILE NO.
green north radius.dwg

COMMONWEALTH OF KENTUCKY
BEFORE THE PUBLIC SERVICE COMMISSION

In the Matter of:

**APPLICATION OF KENTUCKY RSA #4 CELLULAR
GENERAL PARTNERSHIP FOR ISSUANCE OF A
CERTIFICATE OF PUBLIC CONVENIENCE AND
NECESSITY TO CONSTRUCT A CELL SITE (GREEN NORTH)
IN RURAL SERVICE AREA #4 (GREEN) OF
THE COMMONWEALTH OF KENTUCKY**

CASE NO. 2007-00500

AFFIDAVIT OF JOHN E. SELENT

I, John E. Selent, being duly sworn, depose and state as follows:

1. My name is John E. Selent and I am a member of the Kentucky Bar Association.

I am legal counsel to Kentucky RSA #4 Cellular General Partnership and am submitting this affidavit in conjunction with the above referenced matter.

2. In order to demonstrate compliance with 807 KAR 5:063 §1(1)(l) & (m), Exhibit 1 identifies, with the exception of the individuals identified in paragraphs 4 and 5, the names of the residents/tenants and property owners within 500 feet of the proposed tower who have been: (i) notified by written notice of the proposed construction, sufficient postage prepaid, by United States Certified Mail, return receipt requested; (ii) given the Commission docket number under which the application will be processed; and (iii) informed of the right to request intervention.

3. Attached as Exhibit 2 is a copy of the United States Certified Mail return receipt that demonstrates proof of service of the written notice of the proposed construction upon: (1) Randy McCandless; (2) Joseph and Carolyn Cortez; (3) David Perkins Trust c/o David Perkins; (4) Jerry and Janice Willis; (5) Floyd and Sandra Evans; and (6) David Perkins Trust c/o James Cadigan, Jr.. (See Exhibit 1.)

4. Affiant attempted to serve written notice of the proposed construction upon Louis and Wilma Witt (see Exhibit 1) via United States Certified Mail pursuant to 807 KAR 5:063 §1(1)(l) & (m). Service of the written notice of the proposed construction to Louis and Wilma Witt was returned marked "Attempted Not Known." (See Exhibit 3) As of today's date, Louis and Wilma Witt have not been served with written notice of the proposed construction via United States Certified Mail pursuant to 807 KAR 5:063 §1(1)(l) & (m). Therefore, another copy of the written notice of proposed construction was sent to Louis and Wilma Witt via United States First Class Mail.

5. Affiant attempted to serve written notice of the proposed construction upon Robert Coyer and Robert Gibson (see Exhibit 1) via United States Certified Mail pursuant to 807 KAR 5:063 §1(1)(l) & (m). Service of the written notice of the proposed construction to Robert Coyer and Robert Gibson was returned marked "Return to Sender - Unclaimed - Unable to Forward". (See Exhibit 4) As of today's date, Robert Coyer and Robert Gibson have not been served with written notice of the proposed construction via United States Certified Mail pursuant to 807 KAR 5:063 §1(1)(l) & (m). Therefore, another copy of the written notice of proposed construction was sent to Robert Coyer and Robert Gibson via United States First Class Mail.


Further Affiant saith not.



John E. Selent
)
)SS:
)

COMMONWEALTH OF KENTUCKY)
COUNTY OF JEFFERSON)


SUBSCRIBED AND SWORN to before me this 24th day of January, 2008.

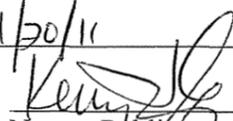My commission expires: 11/20/11


Notary Public

Landmark Surveying Co., Inc.

Darren L. Helms, R.L.S., PRESIDENT
Dennis N. Helms, R.L.S., VICE PRESIDENT

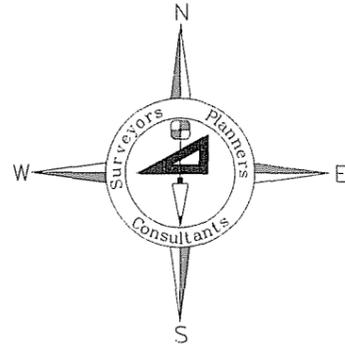

15 N.E. 3rd Street
Washington, Indiana 47501
Phone: 812-257-0950
Fax: 812-257-0953
E-mail: landmark@dmrtc.net

Landowner and Adjacent Landowner List

Bluegrass Cellular
Green North Site
Green County, Kentucky

Louis A. Witt, Sr. and Wilma M. Witt
1843 W. Kentucky Street
Louisville, KY 40210

Jerry K. Willis and Janice M. Willis
263 S. Saint Gregory Church Road
Coxs Creek, KY 40013

Randy McCandless
120 Warren Road
Mt. Sherman, KY 42764


Joseph W. Cortez, Jr. and Carolyn Cortez
14899 Hodgenville Road
Mt. Sherman, KY 42764

David Perkins Trust
c/o James P. Cadigan, Jr.
888 Sand Ridge Road
Magnolia, KY 42757


Robert P. Coyer and Robert Gibson
15063 Hodgenville Road
Mt. Sherman, KY 42764

David Perkins Trust
c/o David Perkins
4628 Greensburg Road
Buffalo, KY 42716

Floyd Evans and Sandra Evans
600 Mt. Sherman-Ward Road
Magnolia, KY 42757

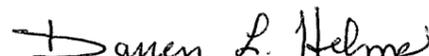
Darren L. Helms, Kentucky Professional Land Surveyor No. 3386

Nov. 26, 2007
Date

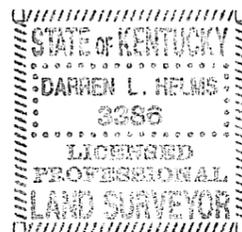

December 6, 2007

Floyd and Sandra Evans
600 Mt. Sherman-Ward Road
Magnolia, Kentucky 42757

Public Notice

Kentucky RSA #4 Cellular General Partnership is a Kentucky general partnership that markets its services as Bluegrass Cellular. Bluegrass Cellular has been serving Central Kentucky with wireless communications services for over 15 years.

Kentucky RSA #4 Cellular General Partnership is applying to the Public Service Commission of the Commonwealth of Kentucky (the "Commission") for a Certificate of Public Convenience and Necessity to construct and a new cell facility to provide cellular telephone service. This facility will include a 240 foot tower to be located at 788 Sand Ridge Road, Magnolia, Kentucky 42757. A map showing the location is attached.

The Commission invites your comments regarding this proposed construction. Also, the Commission wants you to be aware of your right to intervene in this matter. Your comments and request for intervention should be addressed to:

**Executive Director's Office
Public Service Commission of Kentucky
P.O. Box 615
Frankfort, Kentucky, 40602.**

Please refer to case number 2007-00500 in your correspondence.

Bluegrass Cellular welcomes the opportunity to serve and provide wireless service in your community! (For more information, please check us out online at www.myblueworks.com)

SENDER: COMPLETE THIS SECTION	COMPLETE THIS SECTION ON DELIVERY
<ul style="list-style-type: none">Complete items 1, 2, and 3. Also complete item 4 if Restricted Delivery is desired.Print your name and address on the reverse so that we can return the card to you.Attach this card to the back of the mailpiece, or on the front if space permits.	A. Signature <input type="checkbox"/> Agent <input checked="" type="checkbox"/> <i>Sandra L. Evans</i> <input type="checkbox"/> Addressee
1. Article Addressed to: <i>Floyd & Sandra Evans 600 Mt. Sherman-Ward Rd Magnolia, KY 42757</i>	B. Received by (Printed Name) <input type="checkbox"/> Addressee <i>Sandra L. Evans</i> C. Date of Delivery <i>12-7-07</i>
2. Article (Trac) PS For	D. Is delivery address different from item 1? <input type="checkbox"/> Yes If YES, enter delivery address below: <input type="checkbox"/> No
	3. Service Type <input checked="" type="checkbox"/> Certified Mail <input type="checkbox"/> Express Mail <input type="checkbox"/> Registered <input type="checkbox"/> Return Receipt for Merchandise <input type="checkbox"/> Insured Mail <input type="checkbox"/> C.O.D.
	4. Restricted Delivery? (Extra Fee) <input type="checkbox"/> Yes

December 6, 2007

Joseph W. Cortez, Jr. and Carolyn Cortez
14899 Hodgenville Road
Mt. Sherman, Kentucky 42764

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1. Article Addressed to: <i>Joseph Cortez, Jr. + Carolyn Cortez 14899 Hodgenville Rd. Mt. Sherman, KY 42764</i>	B. Received by (Printed Name) <i>Carolyn A. Cortez</i> C. Date of Delivery <i>12-7-07</i>
2. Article Number (Transfer from service label) 7007 2560 0001 2145 5782	D. Is delivery address different from item 1? <input type="checkbox"/> Yes If YES, enter delivery address below: <input type="checkbox"/> No
	3. Service Type <input checked="" type="checkbox"/> Certified Mail <input type="checkbox"/> Express Mail <input type="checkbox"/> Registered <input type="checkbox"/> Return Receipt for Merchandise <input type="checkbox"/> Insured Mail <input type="checkbox"/> C.O.D.
	4. Restricted Delivery? (Extra Fee) <input type="checkbox"/> Yes

December 6, 2007

Jerry K. and Janice M. Willis
263 S. Saint Gregory Church Road
Coxs Creek, Kentucky 40013

Public Notice

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Public Service Commission of Kentucky
P.O. Box 615
Frankfort, Kentucky, 40602.**

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1. Article Addressed to: <i>Jerry K. & Janice Willis 263 S. Saint Gregory Church Rd. COXS CREEK, Kentucky 40013</i>	B. Received by (Printed Name) <i>Jerry Willis</i> C. Date of Delivery <i>12-8-07</i>
2. Article Number (Transfer from service label) <i>7007 2560 0001 2145 5546</i>	D. Is delivery address different from item 1? <input type="checkbox"/> Yes If YES, enter delivery address below: <input type="checkbox"/> No
	3. Service Type <input checked="" type="checkbox"/> Certified Mail <input type="checkbox"/> Express Mail <input type="checkbox"/> Registered <input type="checkbox"/> Return Receipt for Merchandise <input type="checkbox"/> Insured Mail <input type="checkbox"/> C.O.D.
	4. Restricted Delivery? (Extra Fee) <input type="checkbox"/> Yes

December 6, 2007

David Perkins Trust
C/O David Perkins
4628 Greensburg Road
Buffalo, Kentucky 42716

Public Notice

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Frankfort, Kentucky, 40602.**

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1. Article Addressed to: David Perkins Trust C/O David Perkins 4628 Greensburg Rd. Buffalo, Kentucky 42716	B. Received by (Printed Name) DAVID PERKINS C. Date of Delivery 12/7/07
2. Article Number (Transfer from service label) 7007 2560 0001 2145 5553	D. Is delivery address different from item 1? <input checked="" type="checkbox"/> Yes If YES, enter delivery address below: <input type="checkbox"/> No PO Box 53 Buffalo Ky 42716
	3. Service Type <input checked="" type="checkbox"/> Certified Mail <input type="checkbox"/> Express Mail <input type="checkbox"/> Registered <input type="checkbox"/> Return Receipt for Merchandise <input type="checkbox"/> Insured Mail <input type="checkbox"/> C.O.D.
	4. Restricted Delivery? (Extra Fee) <input type="checkbox"/> Yes

December 6, 2007

David Perkins Trust
C/O James P. Cadigan, Jr.
888 Sand Ridge Road
Magnolia, Kentucky 42757

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	B. Received by (Printed Name) <i>James P. Cadigan</i>
	C. Date of Delivery <i>12-10-07</i>
	D. Is delivery address different from item 1? <input checked="" type="checkbox"/> Yes If YES, enter delivery address below: <input type="checkbox"/> No <i>P.O.</i>
1. Article Addressed to: <i>David Perkins Trust C/O James Cadigan, Jr. 888 Sand Ridge Rd. Magnolia, KY 42757</i>	3. Service Type <input checked="" type="checkbox"/> Certified Mail <input type="checkbox"/> Express Mail <input type="checkbox"/> Registered <input type="checkbox"/> Return Receipt for Merchandise <input type="checkbox"/> Insured Mail <input type="checkbox"/> C.O.D.
2. Article Number <i>(Transfer from service label)</i>	4. Restricted Delivery? (Extra Fee) <input type="checkbox"/> Yes
	7007 2560 0001 2145 5744

December 6, 2007

Randy McCandless
120 Warren Road
Mt. Sherman, Kentucky 42764

Public Notice

Kentucky RSA #4 Cellular General Partnership is a Kentucky general partnership that markets its services as Bluegrass Cellular. Bluegrass Cellular has been serving Central Kentucky with wireless communications services for over 15 years.

Kentucky RSA #4 Cellular General Partnership is applying to the Public Service Commission of the Commonwealth of Kentucky (the "Commission") for a Certificate of Public Convenience and Necessity to construct and a new cell facility to provide cellular telephone service. This facility will include a 240 foot tower to be located at 788 Sand Ridge Road, Magnolia, Kentucky 42757. A map showing the location is attached.

The Commission invites your comments regarding this proposed construction. Also, the Commission wants you to be aware of your right to intervene in this matter. Your comments and request for intervention should be addressed to:

**Executive Director's Office
Public Service Commission of Kentucky
P.O. Box 615
Frankfort, Kentucky, 40602.**

Please refer to case number 2007-00500 in your correspondence.

Bluegrass Cellular welcomes the opportunity to serve and provide wireless service in your community! (For more information, please check us out online at www.myblueworks.com)

SENDER: COMPLETE THIS SECTION	COMPLETE THIS SECTION ON DELIVERY
<ul style="list-style-type: none">Complete items 1, 2, and 3. Also complete item 4 if Restricted Delivery is desired.Print your name and address on the reverse so that we can return the card to you.Attach this card to the back of the mailpiece, or on the front if space permits.	A. Signature <i>Randy McCandless</i> <input type="checkbox"/> Agent <i>Randy McCandless</i> <input checked="" type="checkbox"/> Addressee
1. Article Addressed to: <i>Randy McCandless 120 Warren Road Mt. Sherman, KY 42764</i>	B. Received by (Printed Name) C. Date of Delivery
2. Article Number (Transfer from service label) <i>7007 2560 0001 2145 5560</i>	D. Is delivery address different from item 1? <input type="checkbox"/> Yes If YES, enter delivery address below: <input type="checkbox"/> No
	3. Service Type <input checked="" type="checkbox"/> Certified Mail <input type="checkbox"/> Express Mail <input type="checkbox"/> Registered <input type="checkbox"/> Return Receipt for Merchandise <input type="checkbox"/> Insured Mail <input type="checkbox"/> C.O.D.
	4. Restricted Delivery? (Extra Fee) <input type="checkbox"/> Yes

December 6, 2007

Louis A. Witt, Sr. and Wilma M. Witt
1843 W. Kentucky Street
Louisville, Kentucky 40210

Public Notice

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Public Service Commission of Kentucky
P.O. Box 615
Frankfort, Kentucky, 40602.**


Please refer to case number 2007-00500 in your correspondence.

Bluegrass Cellular welcomes the opportunity to serve and provide wireless service in your community! (For more information, please check us out online at www.myblueworks.com)

100 PNC Plaza, 500 West Jefferson Street
Louisville, KY 40202

Dinsmore & Shohl LLP
ATTORNEYS

CERTIFIED MAIL

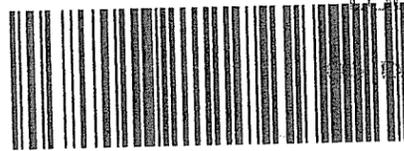

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LOUISVILLE KY 402

DEC 2007



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Louis A. Witt, Sr. and Wilma M. Witt
1843 W. Kentucky Street
Louisville, Kentucky 40210

ATTEMPTED,
NOT KNOWN



December 6, 2007

Robert P. Coyer and Robert Gibson
15063 Hodgenville Road
Mt. Sherman, Kentucky 42764

Public Notice

Kentucky RSA #4 Cellular General Partnership is a Kentucky general partnership that markets its services as Bluegrass Cellular. Bluegrass Cellular has been serving Central Kentucky with wireless communications services for over 15 years.

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Public Service Commission of Kentucky
P.O. Box 615
Frankfort, Kentucky, 40602.**

Please refer to case number 2007-00500 in your correspondence.

Bluegrass Cellular welcomes the opportunity to serve and provide wireless service in your community! (For more information, please check us out online at www.myblueworks.com)

CERTIFIED MAIL™



7007 2560 0001 2145 5775



Robert P. Coyer and Robert Gibson
15063 Hodgenville Road
Mt. Sherman, Kentucky 42764


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PNC Plaza, 500 West Jefferson Street
Lexington, KY 40202

Winsmore & Shohl LLP
ATTORNEYS

Dinsmore & Shohl LLP

ATTORNEYS
Kerry W. Ingle
502-540-2354
kerry.ingle@dinslaw.com

January 24, 2007

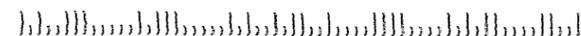Via Certified Mail

Green County Judge Executive
Courthouse
203 West Court Street
Greensburg, Kentucky 42743

RE: Public Notice - Public Service Commission of Kentucky
Case No. 2007-00500


Kentucky RSA #4 Cellular General Partnership is a Kentucky General Partnership that markets its services as Bluegrass Cellular. Kentucky RSA #4 Cellular General Partnership is applying to the Public Service Commission of Kentucky (the Commission) for a Certificate of Public Convenience and Necessity to propose construction and operation for a new facility to provide cellular radio telecommunications service in rural service area (RSA) #4 in Green County. The facility will include a 240 ft. tower and an equipment shelter to be located at 788 Sand Ridge Road, Magnolia, Kentucky, 42757. A map showing the location of the proposed new facility is enclosed.

The Commission invites your comments regarding the proposed construction. You also have the right to intervene in this matter.

Your comments and request for intervention should be addressed to: Executive Director's Office, Public Service Commission, P.O. Box 615, Frankfort, Kentucky 40602. Please refer to case number 2007-00500 in your correspondence.

Very truly yours,

DINSMORE & SHOHL LLP

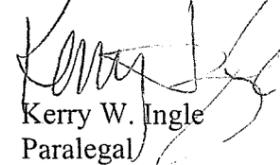
Kerry W. Ingle
Paralegal

enclosure

kwi

SENDER: COMPLETE THIS SECTION	COMPLETE THIS SECTION ON DELIVERY	
<ul style="list-style-type: none"> ■ Complete items 1, 2, and 3. Also complete item 4 if Restricted Delivery is desired. ■ Print your name and address on the reverse so that we can return the card to you. ■ Attach this card to the back of the mailpiece, or on the front if space permits. 	A. Signature <input checked="" type="checkbox"/> <i>Lindsay Landis</i> <input type="checkbox"/> Agent <input type="checkbox"/> Addressee	
1. Article Addressed to: Green County Judge Executive Courthouse 203 W. Court Street. Greensburg, KY 42743	B. Received by (Printed Name) <i>Lindsay Landis</i>	C. Date of Delivery <i>12/7/07</i>
2. Article Number (Transfer from service label)	D. Is delivery address different from item 1? <input type="checkbox"/> Yes If YES, enter delivery address below: <input type="checkbox"/> No	
PS Form 3811, February 2004	3. Service Type <input checked="" type="checkbox"/> Certified Mail <input type="checkbox"/> Express Mail <input type="checkbox"/> Registered <input type="checkbox"/> Return Receipt for Merchandise <input type="checkbox"/> Insured Mail <input type="checkbox"/> C.O.D.	
Domestic Return Receipt	4. Restricted Delivery? (Extra Fee) <input type="checkbox"/> Yes	
102595-02-M-1540	7007 2560 0001 2145 5751	

PUBLIC NOTICE

Kentucky RSA #4 Cellular
General Partnership proposes
to construct a cellular
communications

TOWER

on this site. If you have any
questions please contact:

County Clerk and Engineer	Technical Director
General Partnership	in the State of Kentucky
PO Box 6222	PO Box 6222
Franklin, KY 40501	Franklin, KY 40501


Please refer to P.S.C.

Case #2007-00500

in your correspondence.

PUBLIC NOTICE
A Public Hearing will be held on
Thursday, February 22, 2007
at 7:00 p.m. at the
Town Office Building,
100 North Main Street,
Troy, Michigan 48060.
The purpose of the hearing is to
receive public input on the
proposed
TOWER
located at the intersection of
North Main Street and
East 10th Street, Troy, Michigan.
The proposed tower is shown
on the attached site plan.
If you have any questions
regarding the proposed tower,
please contact the Planning
Department at (313) 247-1234.
Thank you for your participation.

Planning Department
Case # 2007-00500
in your correspondence.

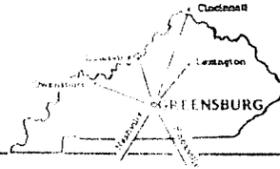

AFFIDAVIT OF PUBLICATION

Before me, a Notary Public, personally appeared

Dana Hagy
who certifies that any and all advertising material
for Dinsmore & Shohl appeared in the
Greensburg Record-Herald on the
date(s): 12/12/07 & 12/19/07


Dana Hagy
Signature

Office Manager - office assistant
Title

State of Kentucky
County of Green

Sworn to and subscribed before me on the 2nd day of
Jan., 2008.

Cheryl E. Blakemore
Notary Public
03/09/2008
My Commission Expires

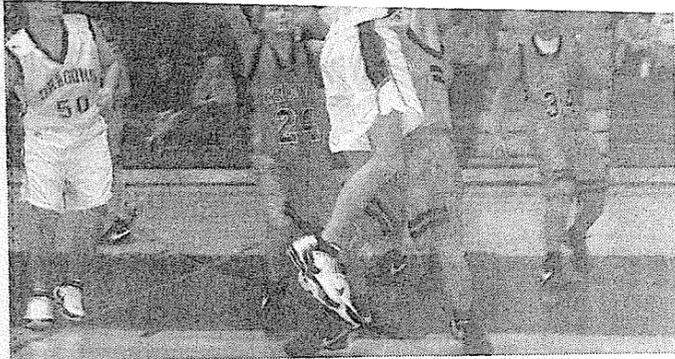

Cody Houchens put up this close-in shot against Grayson County in Saturday's tournament play at Bowling Green. The Dragons led early before falling by a score of 21-28.



Seventh grade guard Brennen Milby looks for GCMS teammate Austin Lowe breaking for the basket on this play. Lowe tied with Koty Cruse and Seth Hedgespeth for Dragon scoring honors against Russell County with four points apiece.

Notice

Kentucky RSA # 4 Cellular General Partnership is applying to the Public Service Commission of Kentucky for a certificate of public convenience and necessity to construct and operate a new facility to provide cellular radio telecommunications service in rural service area # 4 of the Commonwealth of Kentucky (Green North Cell Site). The facility is a 240 foot tower and an equipment shelter to be located at 788 Sand Ridge Road, Magnolia, Kentucky, 42757. Your comments and requests for interventions should be addressed to: Executive Director's Office, Public Service Commission, Post Office Box 615, 211 Sower Boulevard, Frankfort, Kentucky 40602. Please refer to Case No. 2007-00500 in your correspondence.

School Dragons participated in last Saturday's Warren East Middle School Basketball Tournament in Bowling Green. The seventh graders picked up a 34-17 win over Daviess County but lost twice to Bowling Green. Their defeats were by score of 25-46 and 22-36.

The eighth grade Dragons opened tournament play with a 37-27 win over Bowling Green before losing 28-2 to Grayson County. They got knocked out of the double elimination tournament by the same Bowling Green team that they had previously beaten. The Purple got a 53-32 win over Green County in their second meeting of the day. None of the tournament games affect conference standings.

Vi Residential

269 HEATHERTON CIR
3 BR., 2.5 Bath, on 6 acres m/l, 2046 sq
basement, REDUCED \$ 208

1525 RALPH VAUGHN
4 BR., 2 bath on 2 acres, /1 overlooking
buildings, additional acreage availabl

493 PLEASANT RUN CHU
3 BR., 2 bath on 2 lots, 24X56 shop wit
\$239,000.

51 WESLEY DRIV
3 BR., 2 bath brick, partial bsmt., above groun
yard.

LOT #74 WOODSON DRIVE S
3 BR., 2 bath, kitchen
cabinetry, call for price
PENDING

Lot #69 124 Woodso
NEW HOME FOR NEW YEARS! Mak
Resolution to stop renting and own your
the same monthly payment!! 3 bedroom
driveway. Pick your custom colors w
\$106,900

Lot #70 122 Woodso
WHAT A CHRISITMAS PRESENT! Bra
construction, conveniently located to s
feet featuring 3 bedrooms, 2 bath, cr
carport, and priced to make anyone's f
at only \$115,000. Buy now and pick o
cabinets.

Commerc

EAST COLUMBIA A
50x60 building with electric, water, gas
1 bath. REDUCED \$6

ural address in its entirety

affordable for all our people so that every family can provide their children the care they deserve, and so that no senior need go without the medications they need.

We must address these challenges if we are to preserve and protect our quality of life and build the future that we all hope for.

A future where our children don't need to move away to find good-paying jobs with benefits;

A future where new ideas will create new opportunities and new industries; A future where Kentucky is competing not just with our neighbors, but with the world.

I see Kentucky as one big family. We may have our disagreements, but we share the same values and we want what's best for our children and our grandchildren. And we want to keep our families together.

Wouldn't it be something if we could build a Kentucky that our children would not want to leave and that would attract many others because of the opportunity we would offer them here?

The Bible states, in Jere-

miah, chapter 31, verse 17:

"So there is hope for your future," declares the Lord. "Your children will return to their own land."

That, my friends, would be something!

This inauguration is a new beginning. Now is the time to put aside our preconceived notions and our ideologies.

Instead, let us strive to

work with those who differ with us and forge new alliances. Let us consider new ideas and revisit old ones. Let us demand excellence and honesty. And let us listen. For if we listen, we will never forget why we're here or who we're here to serve.

I will never forget that I serve the people of the Commonwealth of Kentucky.

Thank you. God bless.

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www.countrysiderealestate.biz



COUNTRYSIDE
Real Estate, LLC
312 North Columbia Ave. • Campbellville, KY
270-465-7681 • 1-800-482-7722 • Fax 270-789-0737

Farm

Features of the Week

460 JERRY FIELDS ROAD
This 175 acres, m/l, with approx. 30% woods and 70% farm land has 2 barns and a dairy operation, complete with equipment, to go with the 4 bedroom, 2 bath house. This farm features a large pond and 3 all weather springs, creek frontage and a...

395 DONANSBURY SALEM ROAD
55 acres m/l farm with 3 barns, pond.
PENDING
\$132,500.

8499 EDMONTON ROAD
Nice baby farm, 17 acres m/l with brick home-3 BR., 1 bath, full unfinished bsmt., 32X44 barn with good stables and loft, crib barn and pond. Property borders Greasy Creek on back side. \$174,900.

MARSHALL RIDGE ROAD
29 acres m/l, .75 miles of creek frontage, great home sites, 40x56 metal barn w/ water, electric & septic, wooden barn & outbuilding. Also has a Holiday Rambler travel trailer. Misc. farm machinery also avail. \$200,000.


MITCHELL SEMETERY ROAD
17.83 acres open land. **PENDING** for available.

Site Candidate Information

7.5 Minute Map:	Magnolia, KY Quadrangle
Site Name:	Green North ⊗
Latitude:	37-25-41.03 N
Longitude:	85-39-31.79 W
Ground Elevation:	961' (AMSL)
Tower Height:	255' AGL



Search Area Map

7.5 Minute Map:	Magnolia, KY Quadrangle
Site Name:	Green North
Latitude:	37-25-34 N
Longitude:	85-38-15 W
Ground Elevation:	1200' (AMSL)
R/C Height:	240' AGL
Note:	Minimum GE is 1150 ft AMSL

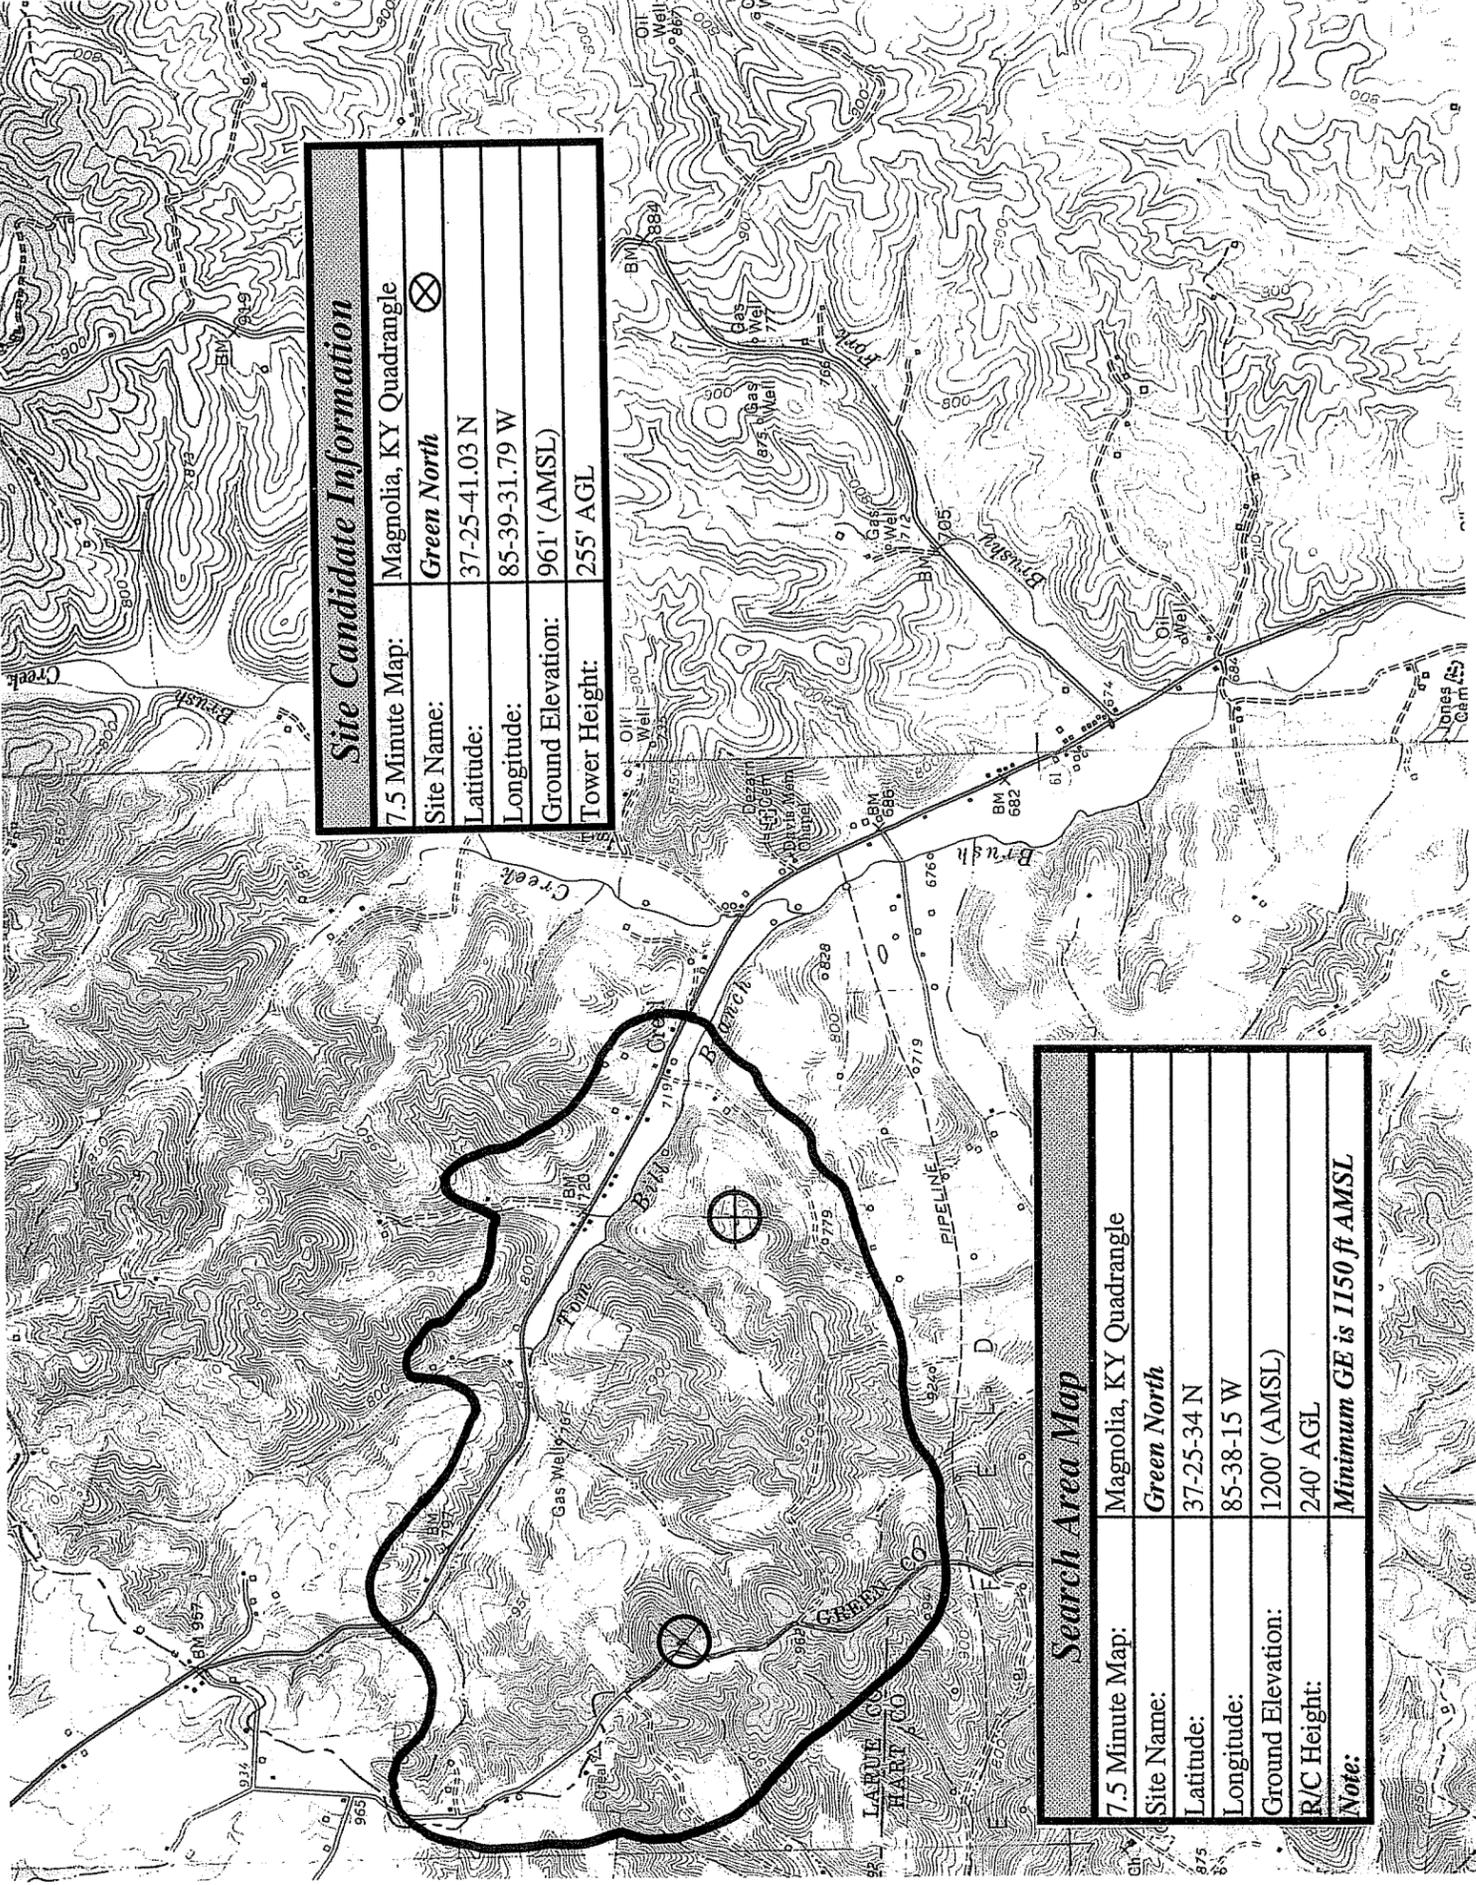

	Larue County Boundary
	Wireless Tower Locations Registered with the FCC
	Proposed Tower location
	Tick Marks

Prepared By: LINGS Engineering 12/12/2007

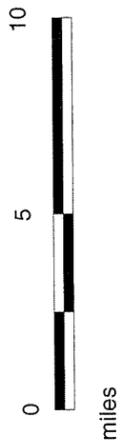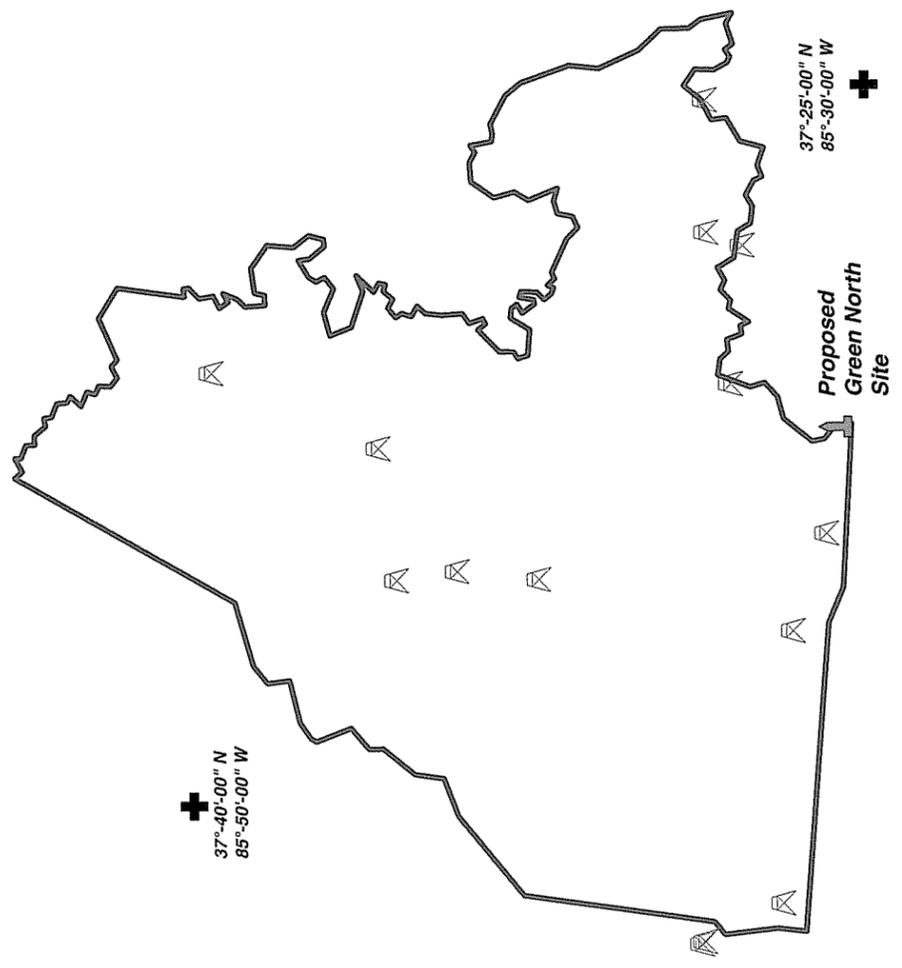

**Information on Constructed Towers Registered with the FCC
in Larue County and 1/2 Mile Area Outside of the County Boundary**

FCC Tower Reg. No.	Nearest City	State	North Lat.	West Lon.	Tower Owner
1002720	Upton	KY	37-28-39	85-53-52	Global Tower, LLC
1042224	Hodgenville	KY	37-28-0	85-38-19	Global Tower, LLC
1043453	Buffalo	KY	37-28-31.7	85-34-5.2	American Towers, Inc.
1044516	Hodgenville	KY	37-28-32.2	85-30-23.9	EAST KENTUCKY POWER COOPERATIVE, INC
1060580	Upton	KY	37-26-54	85-52-48	KENTUCKY RSA 4 CELLULAR GENERAL PARTNERSHIP
1063508	White City	KY	37-35-51	85-40-4	Global Tower, LLC
1200192	Upton	KY	37-28-43	85-53-55.8	Crown Communication Inc.
1227279	Gotton	KY	37-27-43.2	85-34-27.8	Kentucky RSA 4 Cellular General Partnership d/b/a Bluegrass Cellular
1233023	Hodgenville	KY	37-34-6.2	85-43-30.9	SBA Tower, Inc
1239887	New Haven	KY	37-39-32.5	85-37-56.7	Kentucky RSA 4 Cellular General Partnership
1247273	Magnolia	KY	37-25-53.2	85-42-29.9	Louisville Gas and Electric
1248287	Hodgenville	KY	37-35-27	85-43-45.2	Ubiquitel Leasing Company
1251911	Hodgenville	KY	37-32-17.8	85-43-44.5	Kentucky RSA 4 Cellular General Partnership
1254845	Magnolia	KY	37-26-38.8	85-45-12.8	Kentucky RSA 4 Cellular General Partnership